

Tel: +44 (0) 1483 769518 Fax: +44 (0) 1483 770863 E-mail: design@silvatecdesign.com Internet: www.silvatecdesign.com

### TIMBER FRAME STANDARD DETAILS SEPTEMBER 09



### **WORKING IN PARTNERSHIP WITH**









#### **Details on Plan**

- 1. External Wall
  - 1.1. External corner
  - 1.2. Re-entrant corner
  - 1.3. Separating wall junctions
  - 1.4. Non loadbearing wall junctions
  - 1.5. Window/Door Jambs
  - 1.6. Masonry Cladding
  - 1.7. Tile hanging off timber frame
  - 1.8. Timber boarding on timber frame
  - 1.9. Render on timber frame

#### 2. Internal Walls

2.1. Internal wall to internal wall junctions

### 3. Roofs

- 3.1. Access hatch
- 3.2. Tank stand and walkway
- 3.3. Trusses:
  - 3.3.1. Standard truss
  - 3.3.2. Raised tie truss
  - 3.3.3. Attic truss
- 3.4. Bracing Diagonal and longitudinal
  - 3.4.1. Bracing 3D
- 3.5.
  - 3.5.1. Verge Details
  - 3.5.2. Truss parallel to separating wall
  - 3.5.3. Truss perpendicular to separating wall
  - 3.5.4. Truss at right angles to each other at separating wall
- 3.6. Purlins Connections
- 3.7. Rafters
  - 3.7.1 Rafters on floor deck
  - 3.7.2 Rafters on dwarf wall
- 3.8. Roof panels
  - 3.8.1 Roof panel connections
- 3.9. Flat roof Joist and decking
- 3.10. Dormer in Section
- 3.11. Dormer in Perspective view
- 3.12. Parapet detail joists perpendicular
- 3.13. Parapet detail joists parallel

#### **Details in Section**

- 4. External Walls
  - 4.1. Ground Floor
  - 4.2. Intermediate floor Joist parallel
  - 4.3. Intermediate floor Joist perpendicular
  - 4.4. Compartment floor I Joist parallel
  - 4.5. Compartment floor I Joist perpendicular
  - 4.6. Top floor ceiling at eaves



- 4.7. Eaves at window head
- 4.8. Window Cill
- 4.9. Joinery head
- 4.10. Door threshold
- 4.11. Intermediate Floor Open Web Joist Parallel
- 4.12. Intermediate Floor Open Web Joist Perpendicular
- 4.13. Compartment Floor Open Web Parallel
- 4.14. Compartment Floor Open Web Perpendicular
- 4.15. Compartment Floor Solid joist Parallel
- 4.16. Compartment Floor Solid joist Perpendicular
- 4.17. Compartment Floor with Screed Joist Perpendicular
- 4.18. Compartment Floor with Screed Joist Parallel
- 4.19. Compartment Floor with Screedboard Joist Perpendicular
- 4.20. Compartment Floor with Screedboard Joist Parallel

### 5. Internal Walls


- 5.1. Ground floor loadbearing partition
- 5.2. Ground floor non loadbearing partition
- 5.3. Ground floor Separating wall
- 5.4. Upper floor loadbearing partition
- 5.5. Upper floor Non loadbearing partition
- 5.6.
- 5.6.1 Upper floor Separating wall Compartment Floor I joist parallel
- 5.6.2 Upper floor Separating wall Compartment Floor I joist perpendicular
- 5.6.3 Upper floor Separating wall Intermediate Floor I joist parallel
- 5.6.4 Upper floor Separating wall Intermediate Floor I joist perpendicular
- 5.6.5 Upper floor Separating wall Intermediate Floor Open Web parallel
- 5.6.6 Upper floor Separating wall Intermediate Floor Open Web perpendicular
- 5.6.7 Upper floor Separating wall Compartment Floor Open Web parallel
- 5.6.8 Upper floor Separating wall Compartment Floor Open Web perpendicular
- 5.6.9 Upper floor Separating wall Compartment Floor Solid Joist parallel
- 5.6.10 Upper floor Separating wall Compartment Floor Solid Joist perpendicular
- 5.6.11 Upper floor Separating wall Compartment Floor with Screed joists parallel
- 5.6.12 Upper floor Separating wall Comp. Floor with Screed joists perpendicular
- 5.6.13 Upper floor Separating wall Comp. Floor with Screedboard joists parallel
- 5.6.14 Upper floor Separating wall C/Floor with Screedboard joists perpendicular
- 5.7. Ceiling


#### 6. Door Linings

- 6.1. Internal Doors
- 6.2. External Doors
- 6.3. Party wall Entrance Doors

#### 7. Services

- 7.1. Chimney External
- 7.2. Chimney Internal
- 7.3. Specific limitations of notching and drilling joists
- 7.4. Specific limitations of notching and drilling studs
- 7.5. Electrical sockets in separating walls Shallow fitting
- 7.6. Electrical sockets in separating walls Deep fitting

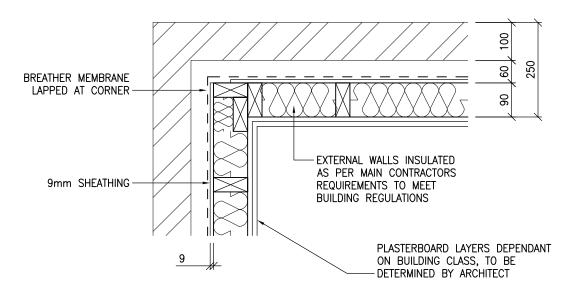


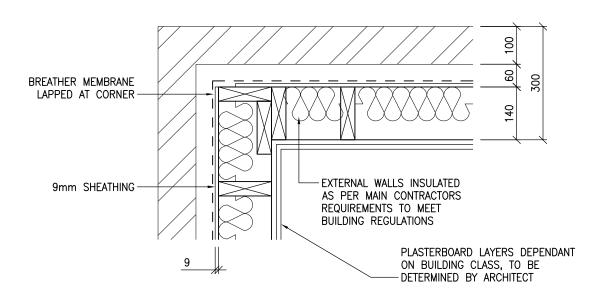




TEL: 01483 769518 FAX: 01483 770863

DRAWING TITLE: EXTERNAL CORNER			
DRAWING No: 1.1	REVISION: -	SCALE: 1:10	
	DATE: JAN 08		

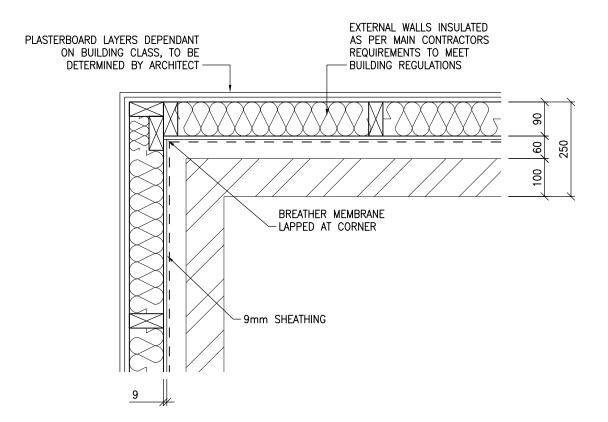

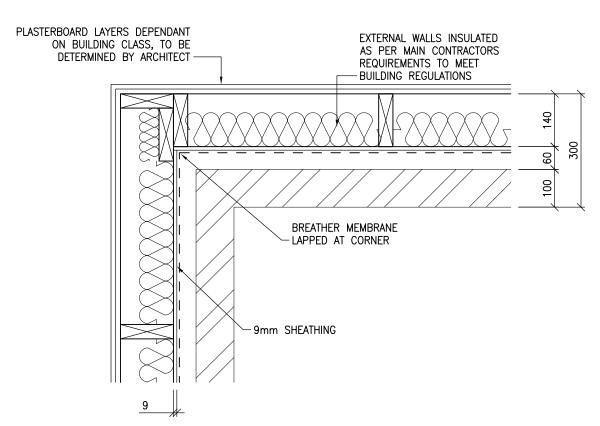



T.KNIGHT

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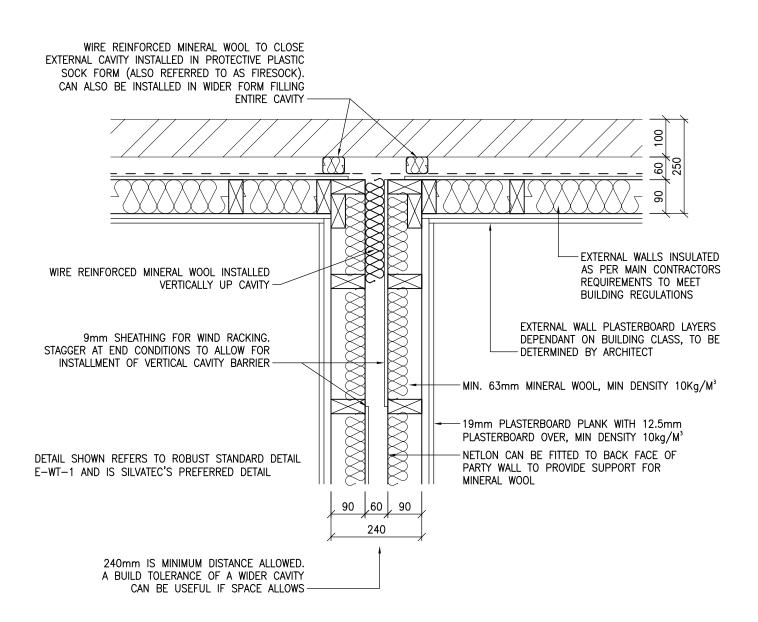
E-MAIL: design@silvatecdesign.com

DRAWING TITLE:
RE-ENTRANT CORNER

DRAWING No: REVISION: SCALE:
1.2 - 1:10

DRAWN BY: DATE:


JAN 08







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SEPARATING WALL JUNCTION		
DRAWING No: 1.3	REVISION: -	SCALE: 1:10
DRAWN BY: T.KNIGHT	DATE: JAN 08	



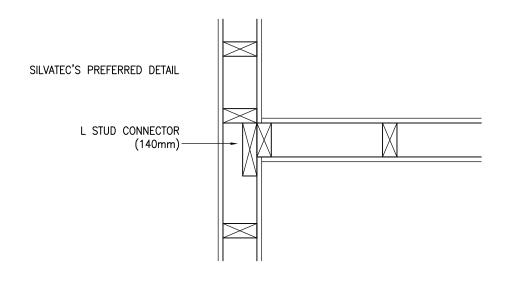

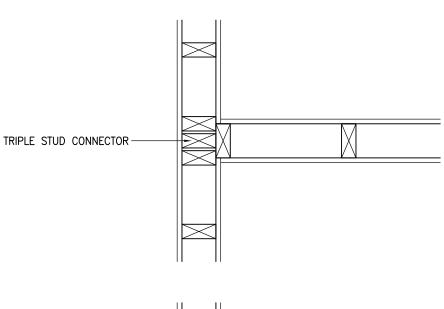

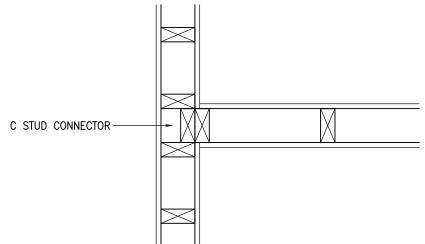


TEL: 01483 769518 FAX: 01483 770863

E-MAIL: design@silvatecdesign.com

# drawing title: NLB WALL JUNCTIONS

DRAWING No: REVISION: SCALE:
1.4 - 1:10


DRAWN BY: DATE:
T.KNIGHT JAN 08

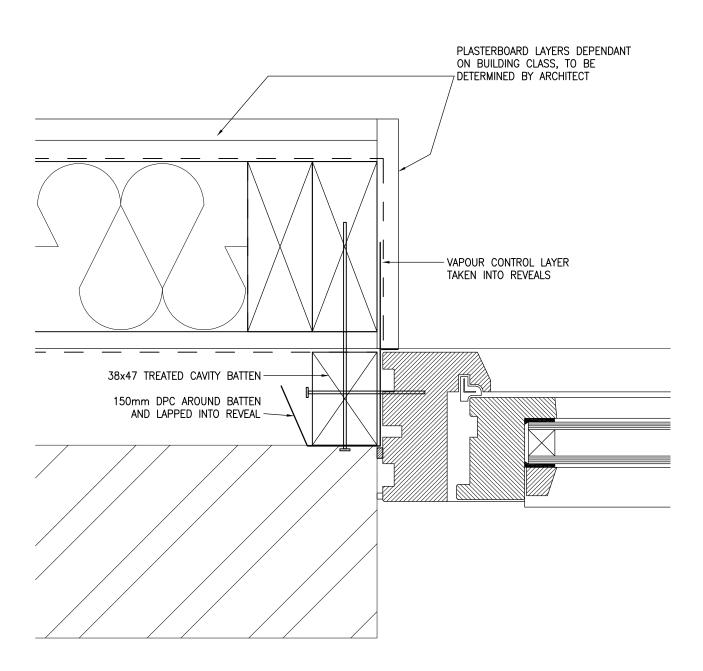



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	DRAWING TITLE:			
WINDOW/DOOR		JAME	3S	
	DRAWING No: 1.5	REVISION: -		SCALE: 1:5
	DRAWN BY: T.KNIGHT	DATE: JAN 08		



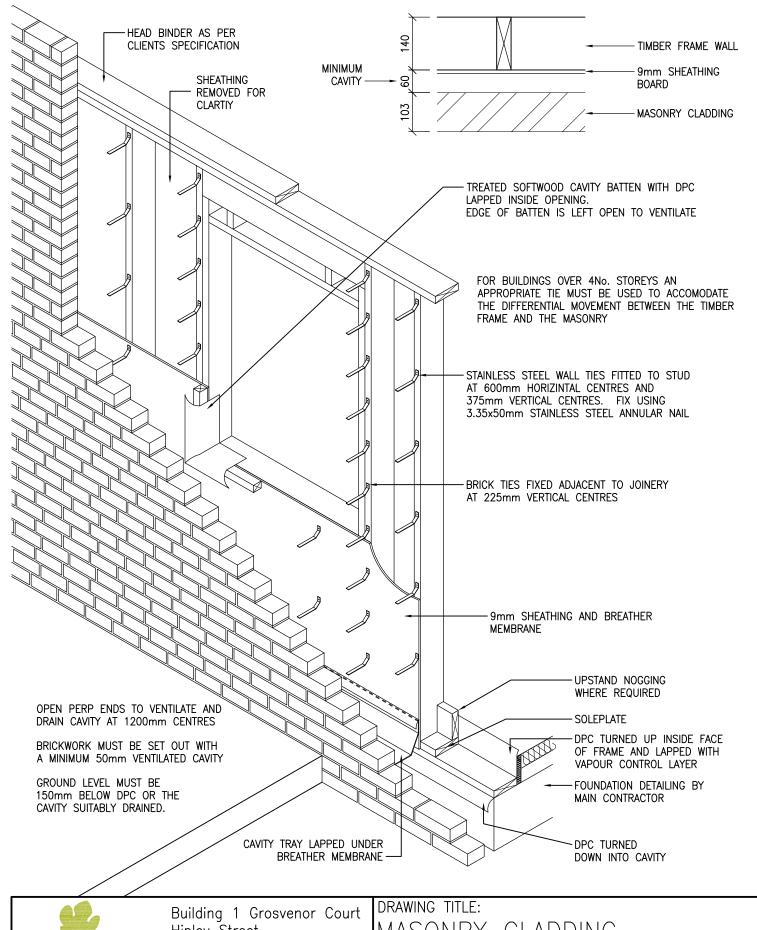

Hipley Street


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GU22 9LL

### MASONRY CLADDING


DRAWING No: **REVISION:** SCALE: 1:20 1.6 DRAWN BY: DATE: T.KNIGHT JAN 08




WHEN USING LIGHTWEIGHT CLADDING ENSURE THAT INSULATION DETAIL WILL CONFORM TO PART L OF THE BUILDING REGULATIONS

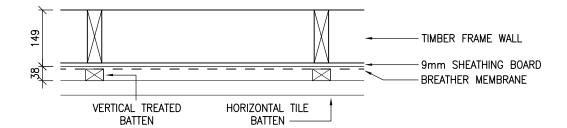ENSURE APPROPRIATE FIRE PROTECTION IS DETAILED WHEN THERE IS A PROPERTY WITHIN CLOSE PROXIMITY

DETAIL SHOWS FIRST BATTEN
AGAINST THE TIMBER FRAME AS
VERTICAL TO ALLOW FOR
VENTILATION AND DRAINAGE OF
CAVITY. IF A HORIZONTAL BATTEN
IS USED AGAINST FRAME ENSURE
TOP EDGE IS SLOPED TO MIN 15'
TO REMOVE WATER FROM
SHEATHING.

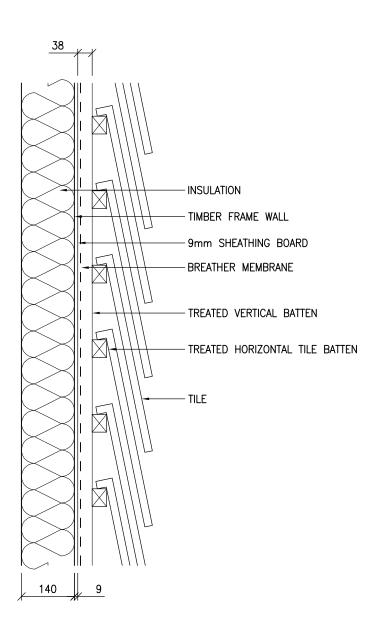

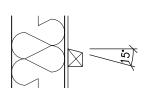




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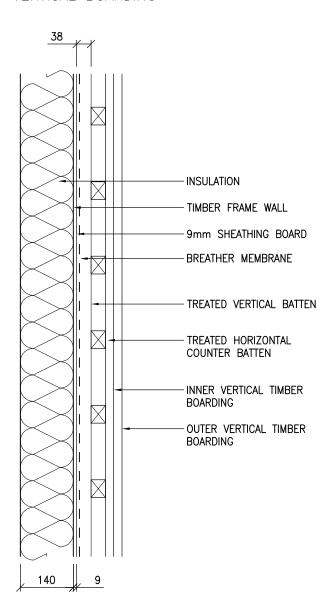
TEL: 01483 769518 FAX: 01483 770863

drawing title: TILE HANGING		
DRAWING No: 1.7	REVISION: A	SCALE: 1:10
DRAWN BY: T.KNIGHT	DATE: JAN 08	

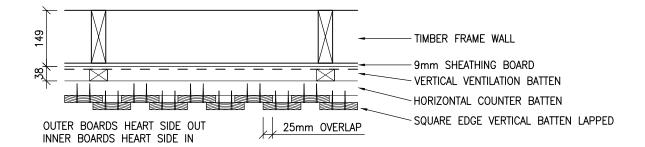


WHEN USING LIGHTWEIGHT CLADDING ENSURE THAT INSULATION DETAIL WILL CONFORM TO PART L OF THE BUILDING REGULATIONS ENSURE APPROPRIATE FIRE PROTECTION IS DETAILED WHEN THERE IS A PROPERTY WITHIN CLOSE PROXIMITY

### VERTICAL BOARDING



### HORIZONTAL BOARDING (SQUARE EDGE BOARDING SHOWN)

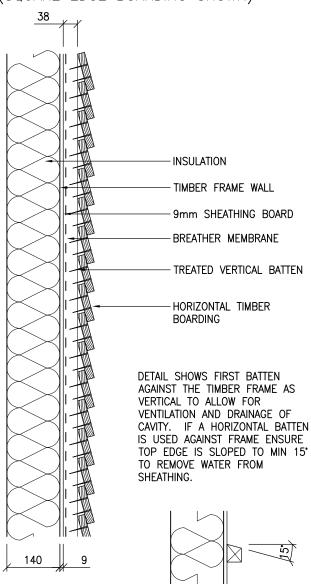




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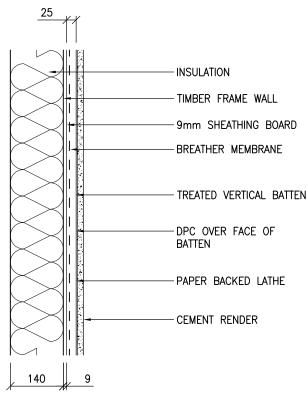
drawing title: TIMBER BOARDING		
DRAWING No: 1.8	REVISION: A	SCALE: 1:10
DRAWN BY: T.KNIGHT	DATE: JAN 08	




NOTE:
CAVITY TO BE A MINIMUM OF
25mm WHEN A PAPER
BACKING IS USED, WHEN
UNBACKED LATHING IS USED
THE CAVITY MUST BE A
MINIMUM OF 50mm

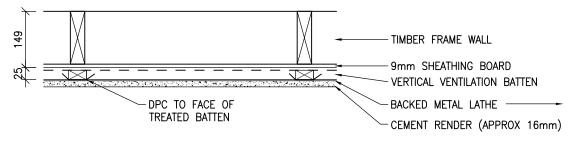WHEN USING LIGHTWEIGHT CLADDING ENSURE THAT INSULATION DETAIL WILL CONFORM TO PART L OF THE BUILDING REGULATIONS ENSURE APPROPRIATE FIRE PROTECTION IS DETAILED WHEN THERE IS A PROPERTY WITHIN CLOSE PROXIMITY

### RENDER ON PAPER BACKED LATHE




### RENDER ON UNBACKED LATHE

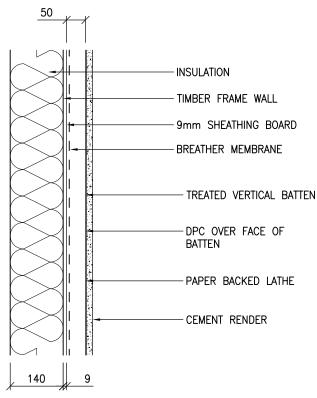

WHEN RENDER IS GREATER THAN ONE STOREY ENSURE MOVEMENT GAPS ARE ALLOWED IN THE BATTEN AT FLOOR ZONE AND MOVEMENT JOINTS WITHIN THE RENDER

RENDER CAN ALSO BE FIXED TO FIBRE CEMENT OR CEMENT-BONDED PARTICLE BOARD CLADDING BOARDS, THESE ARE INSTALLED AS ABOVE IN PLACE OF THE METAL LATHE

DETAIL SHOWS FIRST BATTEN AGAINST THE TIMBER FRAME AS VERTICAL TO ALLOW FOR VENTILATION AND DRAINAGE OF CAVITY. IF A HORIZONTAL BATTEN IS USED AGAINST FRAME ENSURE TOP EDGE IS SLOPED TO MIN 15° TO REMOVE WATER FROM SHEATHING.

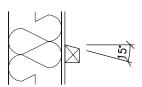




Building 1 Grosvenor Court Hipley Street Old Woking SURREY GU22 9LL


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RENDER	ON TIMBER	FRAME
DRAWING No: 1.9	REVISION: A	SCALE: 1:10
DRAWN BY: T.KNIGHT	DATE: JAN 08	

### INTERNAL WALL TO INTERNAL WALL 1/2 HOUR FIRE RESISTANCE


### INTERNAL WALL TO INTERNAL WALL 1 HOUR FIRE RESISTANCE




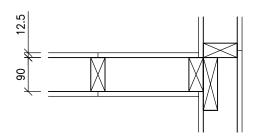
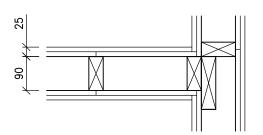
### INTERNAL WALL TO SEPARATNG WALL 1/2 HOUR FIRE RESISTANCE


### INTERNAL WALL TO SEPARATNG WALL 1 HOUR FIRE RESISTANCE

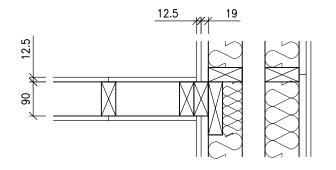


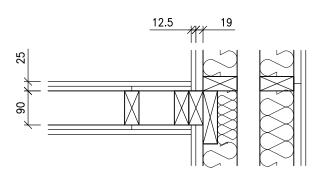

### INTERNAL WALL TO EXTERNAL WALL 1/2 HOUR FIRE RESISTANCE

### INTERNAL WALL TO EXTERNAL WALL 1 HOUR FIRE RESISTANCE

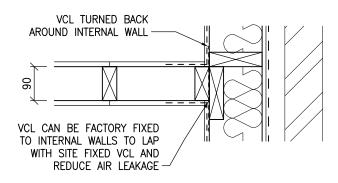

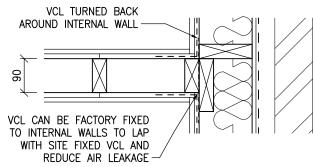




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TEL: 01483 769518 FAX: 01483 770863

drawing title: INTERNAL	WALL JUN	CTIONS
DRAWING No: 2.1	REVISION: A	SCALE: 1:10
	DATE: JAN 08	

### 2B MUST NOT BE MORE THAN 2S-C WHERE S IS THE STANDARD SPACING



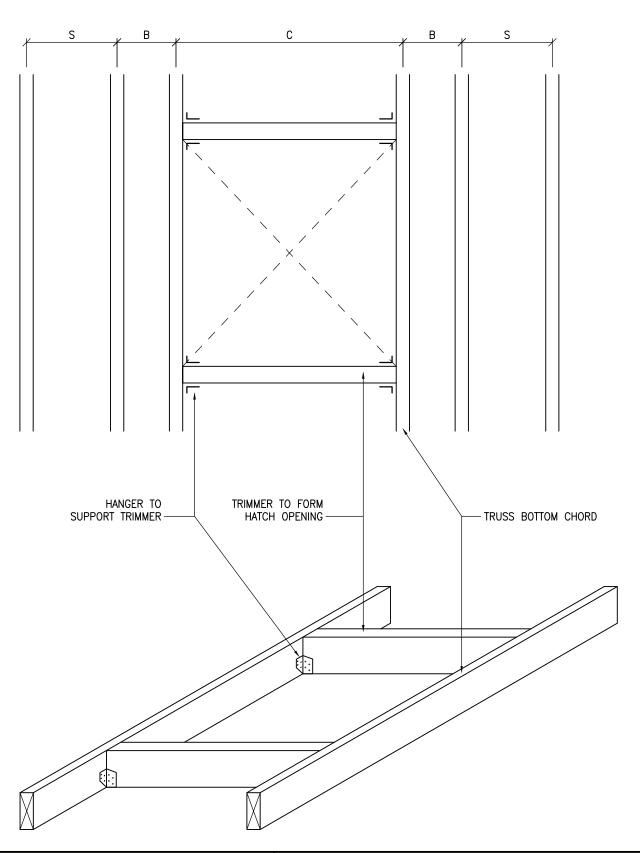

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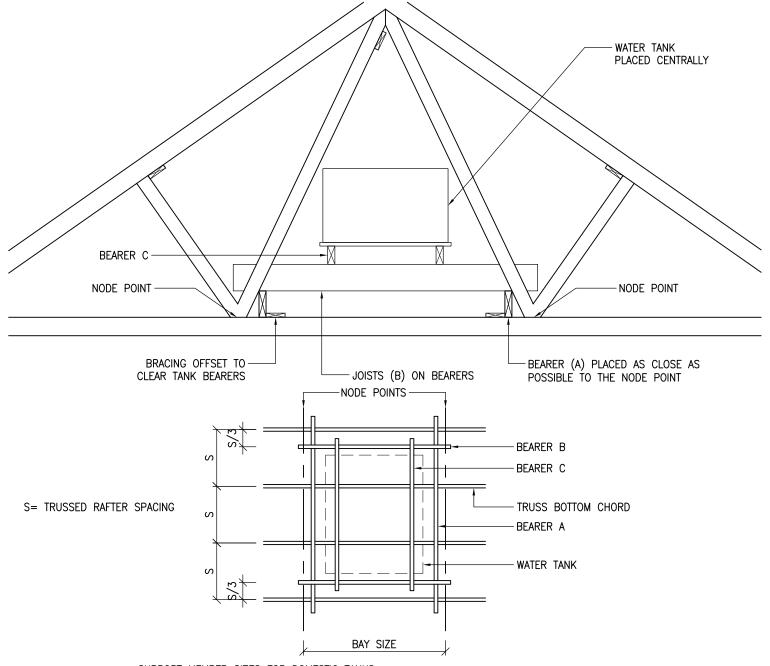
TEL: 01483 769518 FAX: 01483 770863

E-MAIL: design@silvatecdesign.com

drawing title: ROOF ACCESS HATCH

DRAWING No: REVISION: SCALE:
3.1 - 1:10

DRAWN BY: DATE:
T.KNIGHT JAN 08



SUPPORT MEMBER SIZES FOR DOMESTIC TANKS

TANK CAPACITY TO MARKED WATER LINE		BER SIZE (mm)	MAX TRUSSED RAFTER SPAN FOR FINK (M)	MAX BAY SIZE FOR OTHER CONFIGURATIONS (M)
NOT MORE THAN 300 LITRES ON 4No. TRUSSED RAFTERS	47x72	2/35x98 or 1/47x120	6.50	2.20
	47x72	2/35x120 or 1/47x145	9.00	2.80
	47x72	2/35x145	12.00	3.80
NOT MORE THAN 230 LITRES ON 3No. TRUSSED	47x72	1/47x97	6.50	2.20
RAFTERS	47x72	2/35x97 or 1/47x120	9.00	2.80
	47x72	2/35x120 or 1/47x145	12.00	3.80



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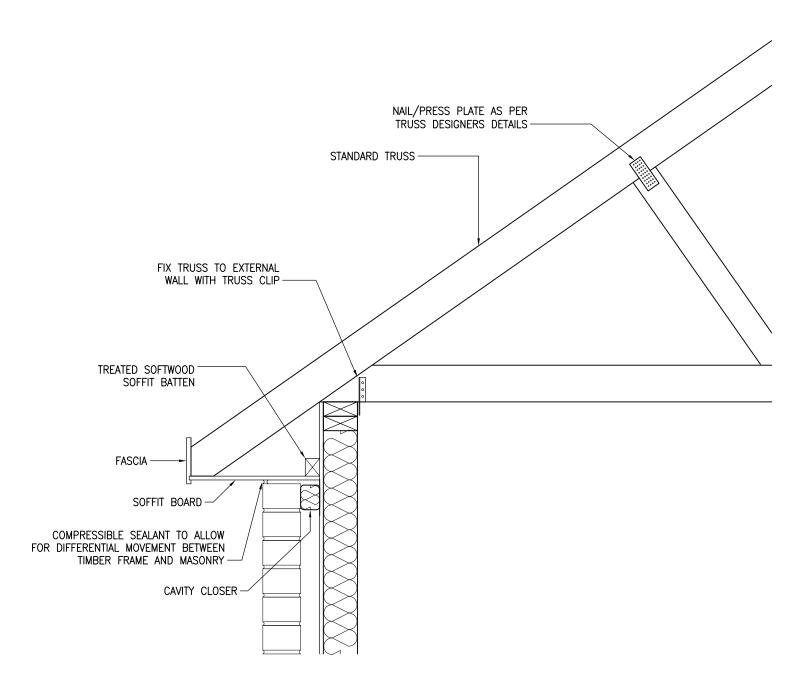
TEL: 01483 769518 FAX: 01483 770863

E-MAIL: design@silvatecdesign.com

DRAWING TITLE:
TANK STAND

DRAWING No: REVISION: SCALE:
3.2 - 1:10

DRAWN BY: DATE:
T.KNIGHT JAN 08



T.KNIGHT



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Hipley Street
Old Woking
SURREY
GU22 911


EL: 01483 7605

TEL: 01483 769518 FAX: 01483 770863

E-MAIL: design@silvatecdesign.com

drawing title: STANDARD TRUSS		
DRAWING No: 3.3.1	REVISION: -	SCALE: 1:20
DRAWN BY	DATF:	


JAN 08

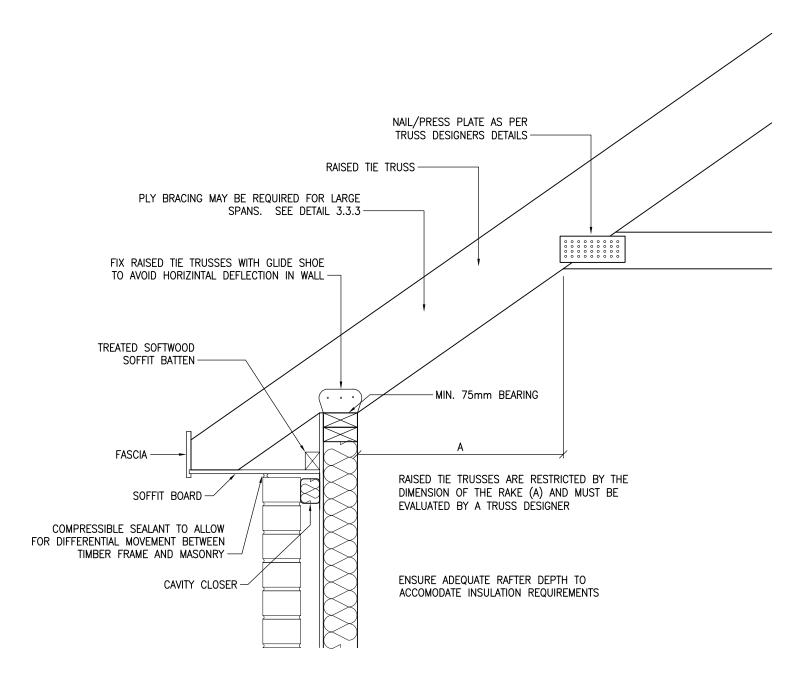




TEL: 01483 769518 FAX: 01483 770863

DRAWING TITLE: RAISED TIE TRUSS		
DRAWING No: 3.3.2	REVISION: A	SCALE: 1:20
DRAWN BY: T.KNIGHT	DATE: JAN 08	

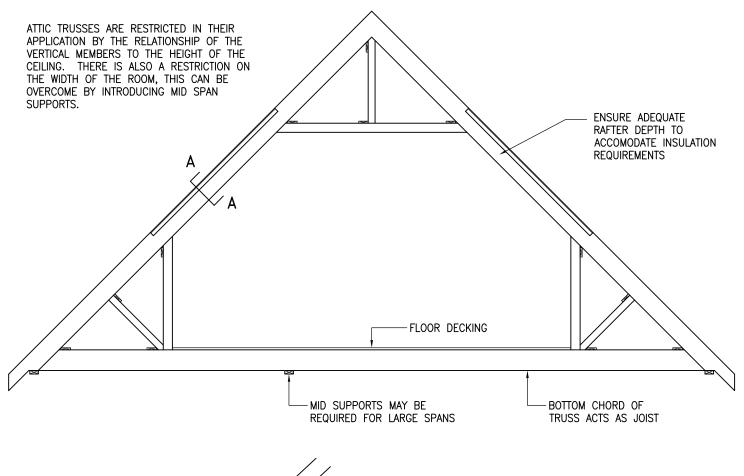

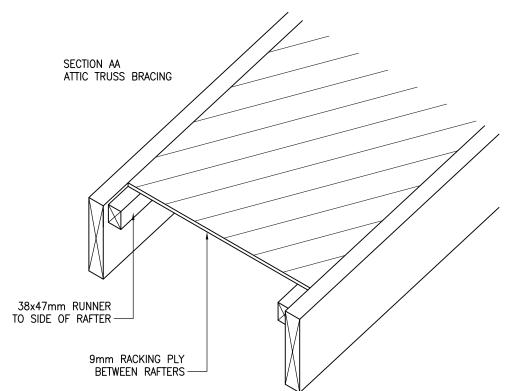



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Old Woking SURREY GU22 at 1


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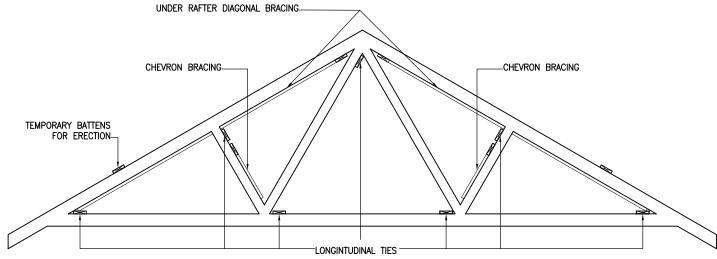
TEL: 01483 769518 FAX: 01483 770863

DRAWING TITLE: ATTIC TRUSS			
	DRAWING No: 3.3.3	REVISION: A	SCALE: 1:10
	DRAWN BY: T.KNIGHT	DATE: JAN 08	

### READ IN CONJUNCTION WITH DETAIL 3.4.1 - 3D ROOF BRACING

 UNDER RAFTER DIAGONAL BRACING: REPEAT CONTINUOUSLY ALONG ROOF ENSURING THEY COVER MINIMUM 3No. RAFTERS. WHERE LAP JOINTS ARE REQUIRED ENSURE THEY ARE TAKEN OVER 2No. TRUSSES. ALTERNATE DIRECTION OF BRACING ALONG THE ROOF.
 LONGITUDINAL TIES: RUN ALONG ENTIRE LENGTH OF ROOF INSTALLED AS CLOSE TO NODE POINT AS POSSIBLE. SET DOWN TOP OF LONGITUDINAL TIES TO ALLOW UNDER RAFTER BRACING TO RUN THROUGH.
 CHEVRON BRACING: FIXED AT APPROXIMATELY 45° AND NAILED TO AT LEAST 3No. TRUSSES. REQUIRED AS NECESSARY TO SUIT RS5268 PART 3



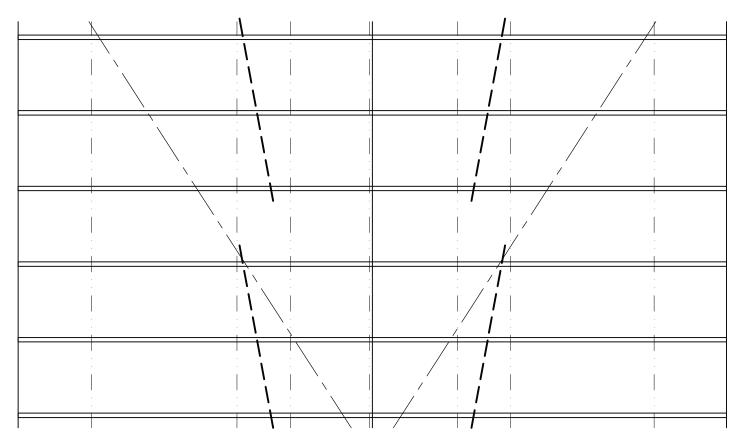



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DRAWING TITLE:


ROOF BR

TEL: 01483 769518 FAX: 01483 770863


ROOF BRACING		
DRAWING No: 3.4	REVISION: A	SCALE: NTS
DRAWN BY: T.KNIGHT	DATE: JAN 08	


A = UNDER RAFTER BRACING
B = LONGITUDINAL BRACINNG
C = CHEVRON BRACING READ IN CONJUNCTION WITH DETAIL 3.4 FOR PLAN LAYOUT OF BRACING UNDER RAFTER BRACING-TEMPORARY BATTEN WALL PLATE-LONGITUDINAL BRACING LONGITUDINAL BRACING-E-MAIL: design@silvatecdesign.com TEL: 01483 769518 FAX: 01483 770863 TEMPORARY BATTEN-SURREY GU22 9LL Old Woking Building 1 Grosvenor Court Hipley Street LONGITUDINAL BRACING CHEVRON BRACING ALL BRACINGS TO BE INSTALLED AS CLOSE TO NODE POINTS AS POSSIBLE TRUSS BRACING TO BE A MINIMUM OF  $22mm \times 100mm$  AND FIXED WITH  $2No.\ 3.35 \times 65mm$  GALVANISED WIRE NAILS AT EACH CROSS 3D ROOF BRACING 3.4.1 LONGITUDINAL BRACING DRAWN BY: DRAWING No: T.KNIGHT UNDER RAFTER BRACING RESTRAIN FIRST TRUSS WITH RAKING BRACING AND FIX TEMPORARY BATTEN TO OUTSIDE OF TRUSSES. DO NOT REMOVE TEMPORARY BRACES UNTIL ROOF FULLY BRACED OUT DATE: REVISION: JAN 08 LONGITUDINAL BRACING CHEVRON BRACING SIN SCALE: WALL PLATE

### OVERHANGING VERGE DETAIL

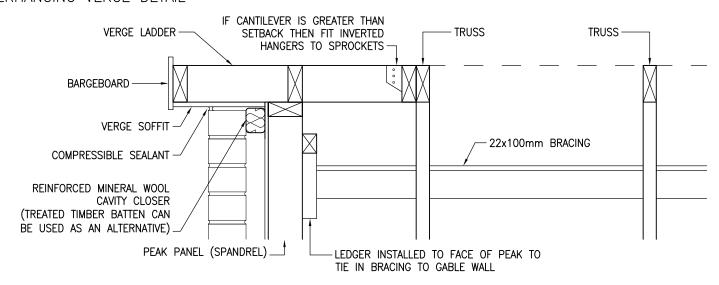

### FLUSH VERGE DETAIL

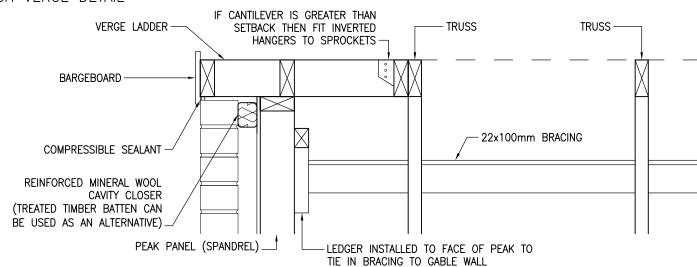

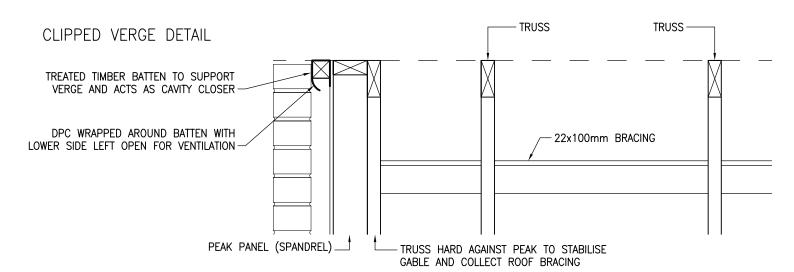

DRAWING TITLE.



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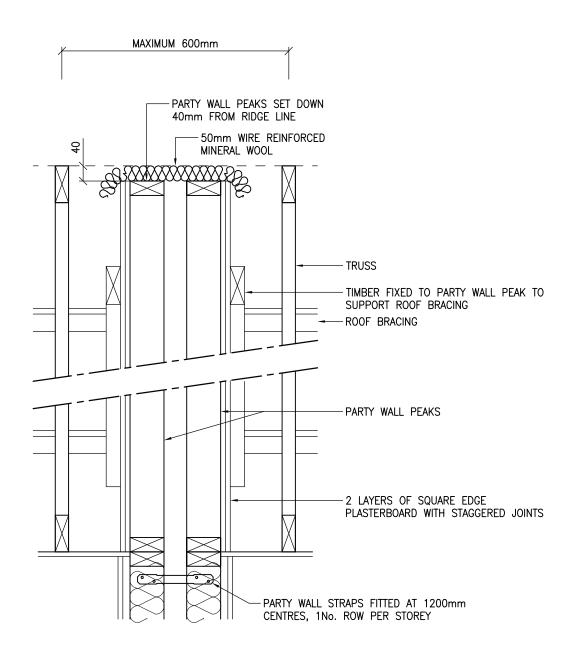
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ı	DIVAWING TITLE.			
	VERGE DETAILS			
	DRAWING No:	REVISION:	SCALE:	
	3.5.1		1:10	
ı				

DRAWN BY: DATE: T.KNIGHT JAN 08




# NOTE: DETAIL SHOWN IS FOR A "SOFT PEAK". IF PARTY WALL PEAKS ARE NOT SET DOWN, OR THE TRUSSES ARE NOT SET AT A MAXIMUM OF 600mm ABOUT THE CENTRELINE, THEN THE TILE BATTEN WILL BE FORCED TO BEAR ON THE PEAKS. AS THE TRUSSES WILL DEFLECT RELATIVE TO THE PEAKS THEN OVER TIME A RAISED SECTION WILL BE FORMED IN THE ROOF PLANE. THIS IS REFERRED TO AS A "HARD PEAK" AND SHOULD BE AVOIDED.



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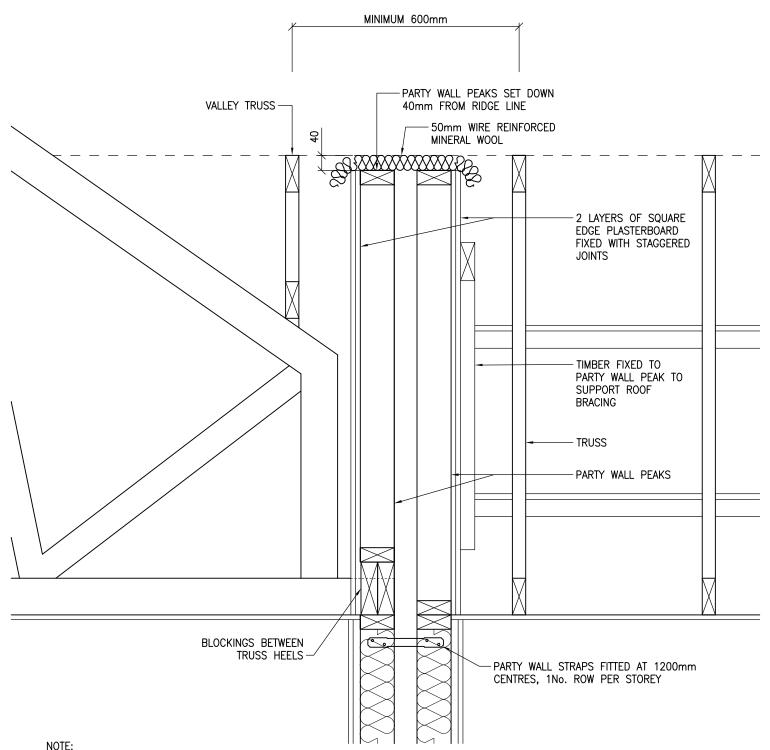
DRAWING TITLE: TRUSS PARALLEL TO SEPARATING WALL		
DRAWING No: 3.5.2	REVISION: A	SCALE: 1:10
DRAWN BY: T.KNIGHT	DATE: JAN 08	



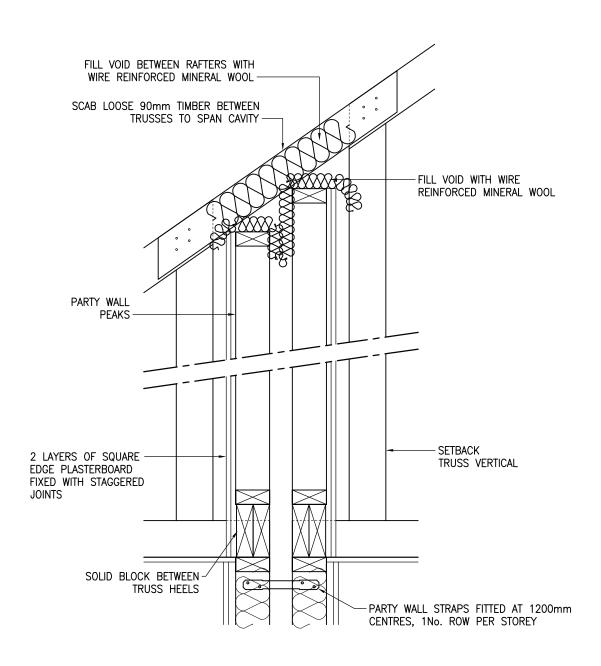

TEL: 01483 769518 FAX: 01483 770863

DRAWING TITLE: TRUSS PERPENDICULAR TO SEPARATING WALL			
DRAWING No: 3.5.3	REVISION: -	SCALE: 1:10	
DRAWN BY: T.KNIGHT	DATE: JAN 08		



DETAIL SHOWN IS FOR A "SOFT PEAK". IF PARTY WALL PEAKS ARE NOT SET DOWN, OR THE TRUSSES ARE NOT SET AT A MAXIMUM OF 600mm ABOUT THE CENTRELINE, THEN THE TILE BATTEN WILL BE FORCED TO BEAR ON THE PEAKS. AS THE TRUSSES WILL DEFLECT RELATIVE TO THE PEAKS THEN OVER TIME A RAISED SECTION WILL BE FORMED IN THE ROOF PLANE. THIS IS REFERRED TO AS A "HARD PEAK" AND SHOULD BE AVOIDED.




Building 1 Grosvenor Court Hipley Street

GU22 9LL

TEL: 01483 769518 FAX: 01483 770863

E-MAIL: design@silvatecdesign.com


DRAWING TITLE: TRUSS AT RIGHT ANGLES TO EACH OTHER AT SEPARATING WALL DRAWING No: **REVISION:** SCALE: 3.5.4 1:10 Α DRAWN BY: DATE: T.KNIGHT JAN 08

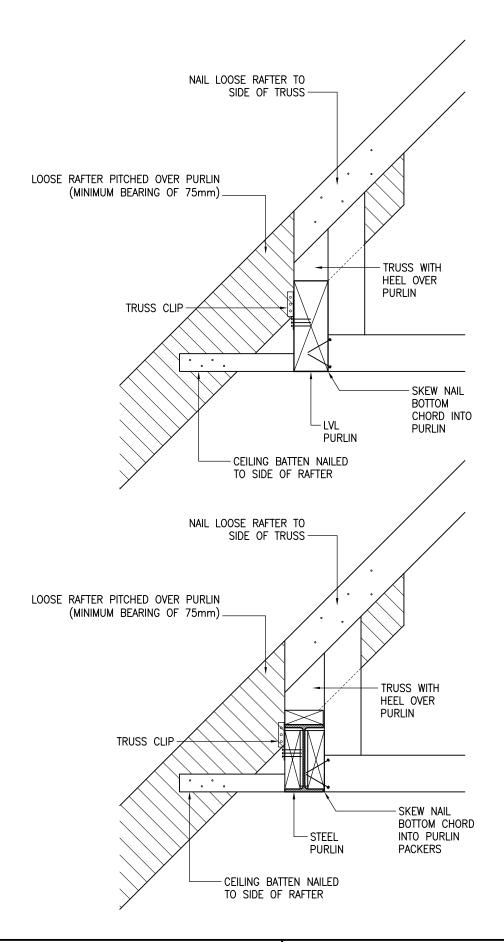




TEL: 01483 769518 FAX: 01483 770863

PURLIN CONNECTIONS		
DRAWING No:	REVISION:	SCALE:
3.6	Α	1:10
DRAWN BY:	DATE:	
T.KNIGHT	JAN 08	

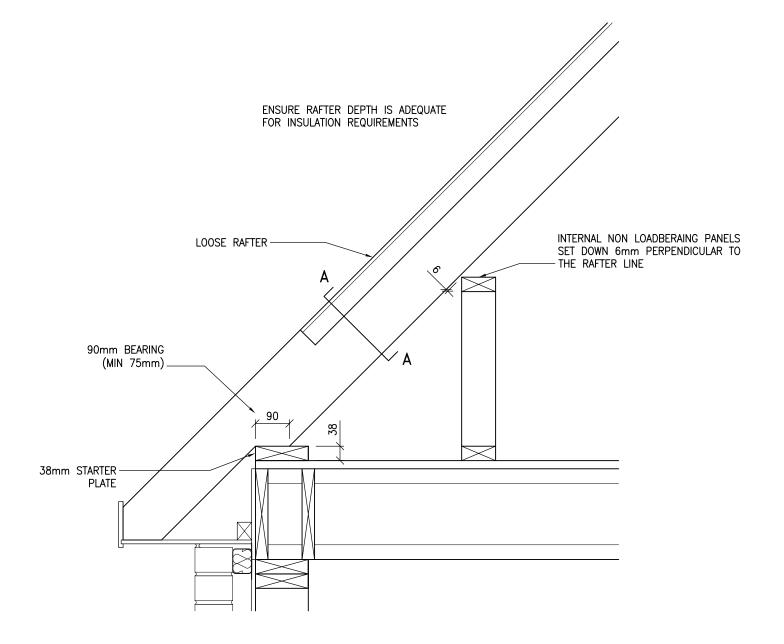


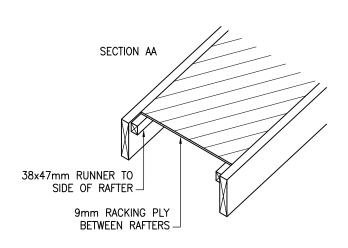



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DRAWING TITLE:		
RAFTERS	ON FLOOR	: DECK
DRAWING No:	REVISION:	SCALE:
3.7.1	A	1:10
	DATE:	
	JAN 08	



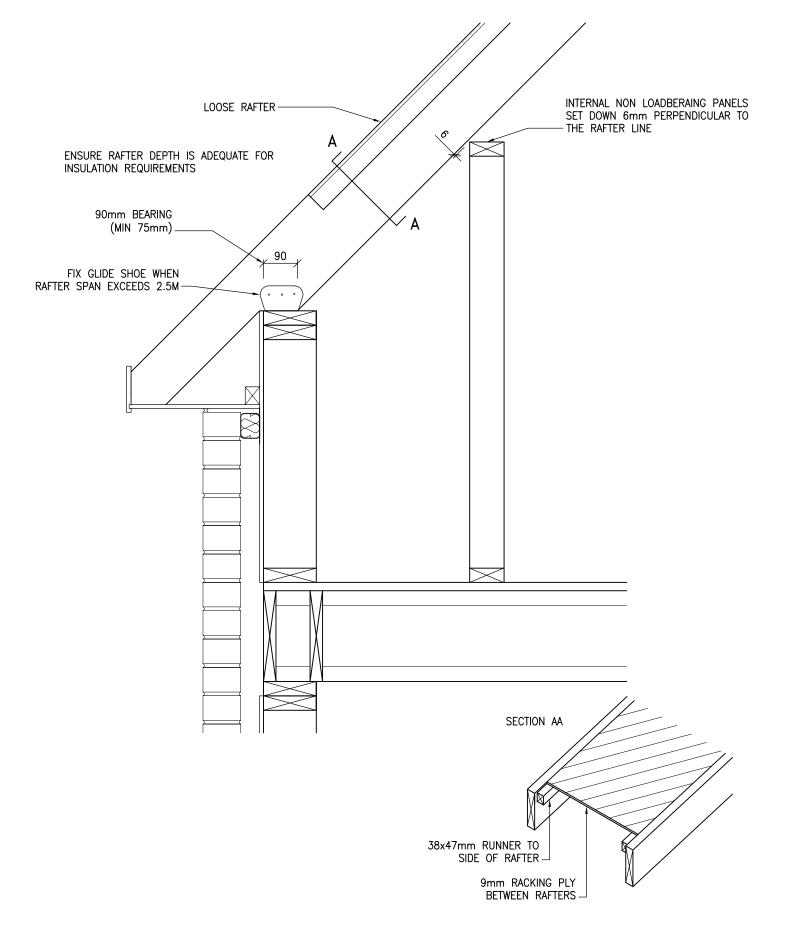



TEL: 01483 769518 FAX: 01483 770863

E-MAIL: design@silvatecdesign.com

DRAWING TITLE: RAFTERS ON DWARF WALL

DRAWING No: **REVISION:** SCALE: 3.7.2 1:10 Α DRAWN BY: DATE: T.KNIGHT JAN 08

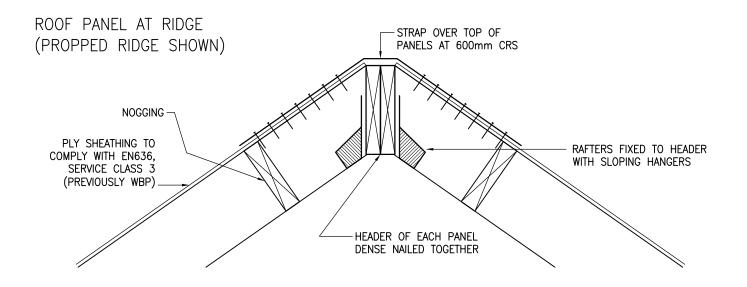

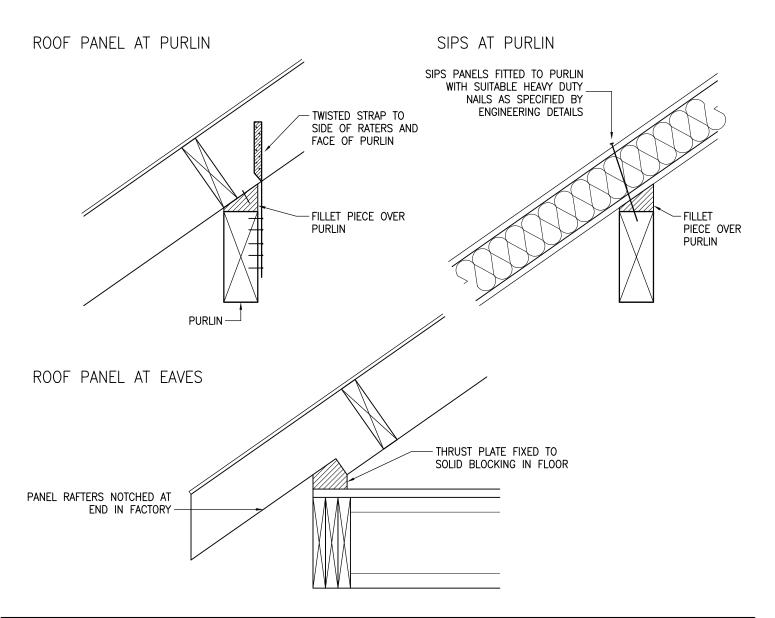




TEL: 01483 769518 FAX: 01483 770863


E-MAIL: design@silvatecdesign.com

DRAWING TITLE:
ROOF PANEL CONNECTIONS

DRAWING No: REVISION: SCALE:
3.8.1 - 1:10

DRAWN BY: DATE:
T.KNIGHT JAN 08

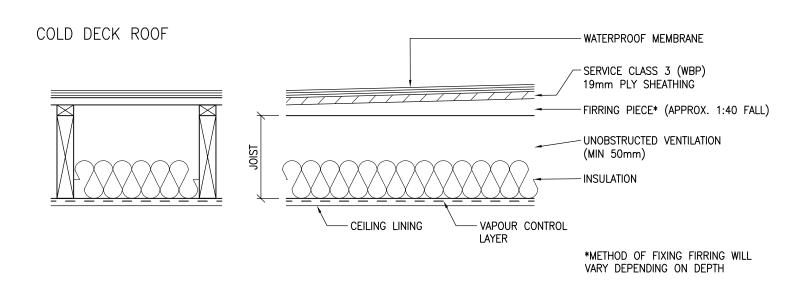


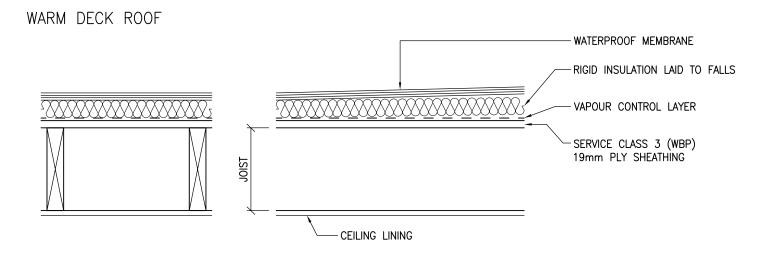



TEL: 01483 769518 FAX: 01483 770863

DRAWING TITLE: FLAT ROC	DF JOISTS .	AND DECK
DRAWING No: 3.9	REVISION: -	SCALE: 1:10
DRAWN BY: T.KNIGHT	DATE: JAN 08	

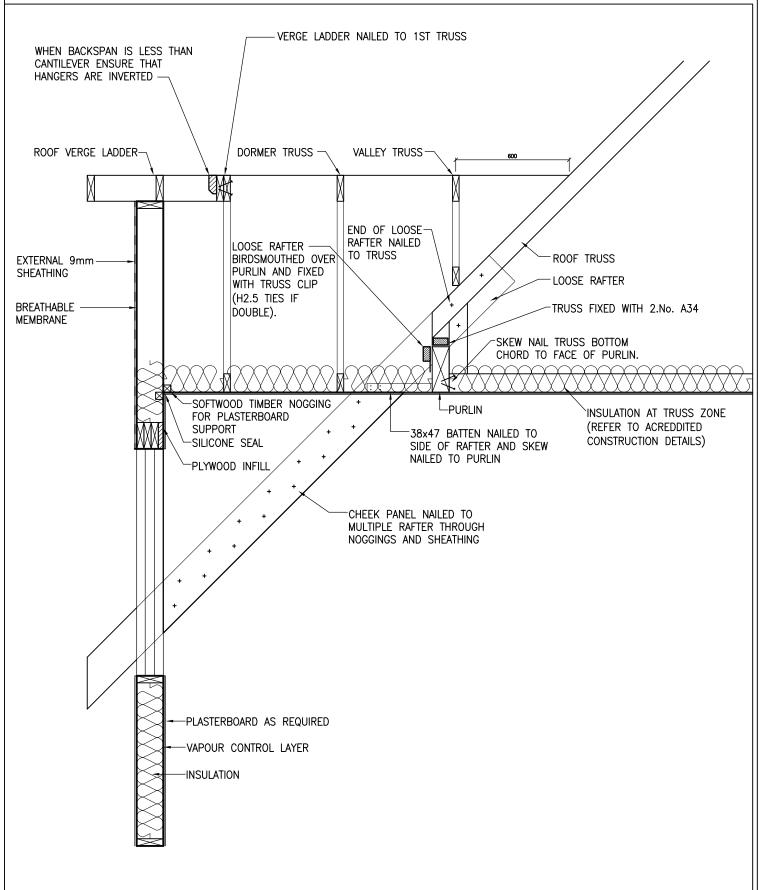

TO SEE DETAIL IN PERSPECTIEVE, REFER TO DRAWING No.1.2



Building 1 Grosvenor Court Hipley Street Old Woking SURREY GU22 9LL


TEL: 01483 769518 FAX: 01483 770863

E-MAIL: design@silvatecdesign.com

## DORMER—SECTION

DRAWING No: REVISION: SCALE:
3.10 - 1:20

DRAWN BY: DATE:
M.SINGLIAR APR 08

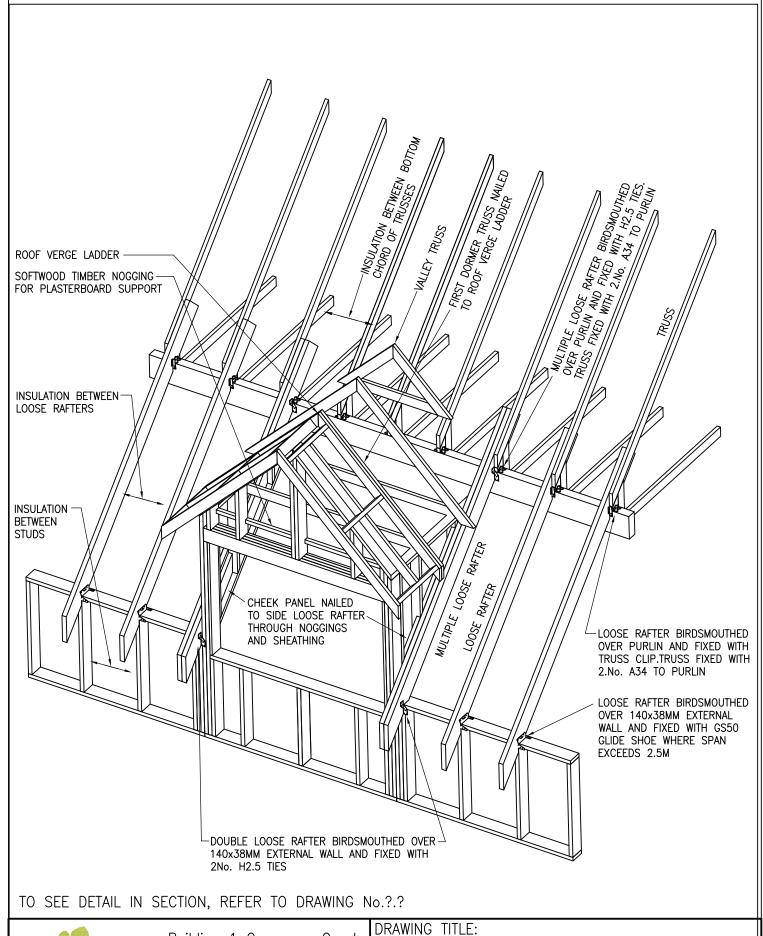




TEL: 01483 769518 FAX: 01483 770863

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DORMER - PERSPECTIVE

DRAWING No: **REVISION:** SCALE: NTS 3.11 DRAWN BY: DATE: M.SINGLIAR APR 08

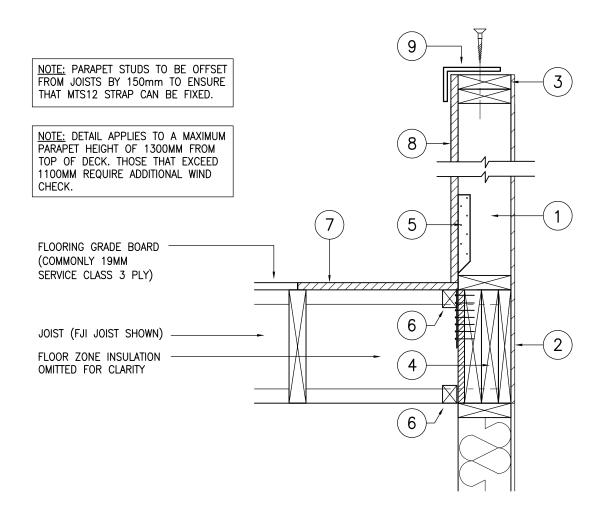

#### **ERECT SEQUENCE**

- 1. FIX PANEL DOWN TO HEADER BEAM
- 2. FIX DOWNSTAND SHEATHING TO OUTSIDE OF HEADER BEAM
- 3. FIX  $38 \times 140$  TOP TIE RAIL
- 4. FIX KERTO BLOCKINGS & PLY TO HEADER (IF NOT DONE IN FACTORY)
- 5. FIX 2 No. MTS12 TWIST STRAPS TO EVERY PARAPET STUD AT 300mm CENTRES AND DOWN FACE OF HEADER BEAM
- 6. FIX 38 x 47 NOGGIN TO INSIDE FACE OF BLOCKING (AT BOTH TOP & BOTTOM)
- 7. FIX 19mm PLY INFILL DECK
- 8. FIX 19mm UPSTAND PLY
- 9. IF PARAPET HEIGHT IS GREATER THAN 4500MM FIX ANGLE TO TOP OF RAIL WITH 10MM COACH SCREWS

PLEASE NOTE THAT THIS DETAIL IS A CONSTRCUTION AID AND SILVATEC CANNOT TAKE ANY RESPONSIBILITY FOR THIS DETAIL ON ANY PROJECT WHERE SILVATEC DESIGN HAVE NOT UNDERTAKEN THE ENGINEERING.



Building 1 Grosvenor Court Hipley Street Old Woking SURREY GU22 9LL


TEL: 01483 769518 FAX: 01483 770863

E-MAIL: design@silvatecdesign.com

DRAWING TITLE:
PARAPET FIXING — JOISTS PERPENDICULAR

DRAWING No: REVISION: SCALE:
3.12 — 1:10

DRAWN BY: DATE:
T.ROBERTS DEC 08

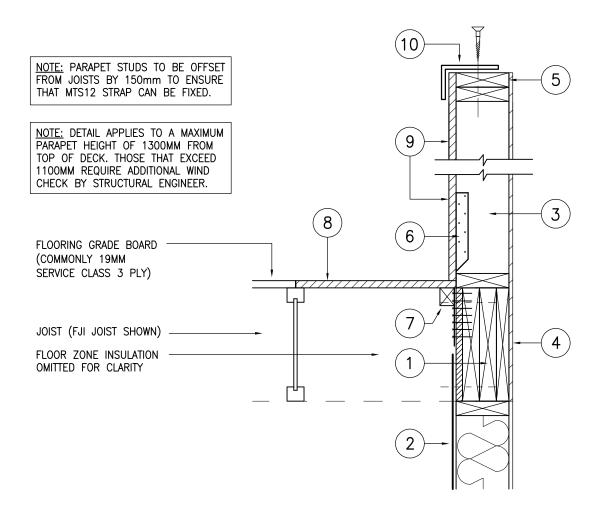

#### **ERECT SEQUENCE**

- 1. FIX KERTO BLOCKINGS & PLY TO HEADER (IF NOT DONE IN FACTORY)
- 2. FIX HEADER BEAM TO EVERY STUD WITH LSTA18 STRAIGHT STRAP
- 3. FIX PANEL DOWN TO HEADER BEAM
- 4. FIX DOWNSTAND SHEATHING TO OUTSIDE OF HEADER BEAM
- 5. FIX 38 x 140 TOP TIE RAIL
- 6. FIX 2 No. MTS12 TWIST STRAPS TO EVERY PARAPET STUD AT 300mm CENTRES AND DOWN FACE OF HEADER BEAM
- 7. FIX 38 x 47 NOGGIN TO INSIDE FACE OF BLOCKING (AT BOTH TOP & BOTTOM)
- 8. FIX 19mm PLY INFILL DECK
- 9. FIX 19mm UPSTAND PLY
- 10. IF PARAPET LENGTH IS GREATER THAN 4500MM FIX ANGLE TO TOP OF RAIL WITH 10MM COACHSCREWS

PLEASE NOTE THAT THIS DETAIL IS A CONSTRCUTION AID AND SILVATEC CANNOT TAKE ANY RESPONSIBILITY FOR THIS DETAIL ON ANY PROJECT WHERE SILVATEC DESIGN HAVE NOT UNDERTAKEN THE ENGINEERING.



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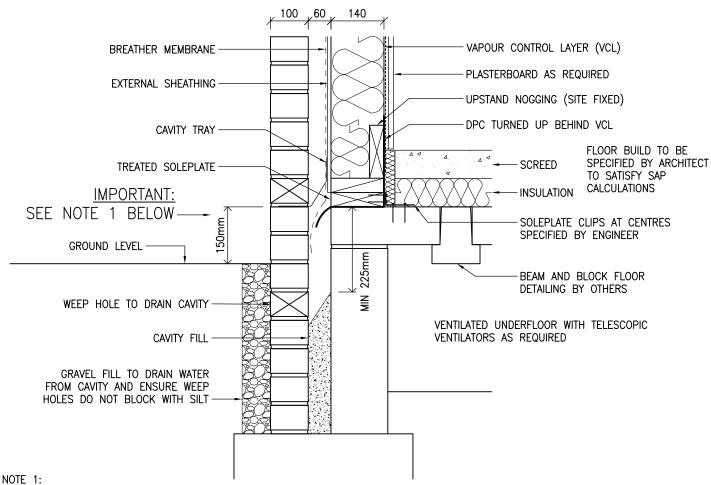
E-MAIL: design@silvatecdesign.com

DRAWING TITLE:
PARAPET FIXING — JOISTS PARALLEL

DRAWING No: REVISION: SCALE:
3.13 — 1:10


DRAWN BY: DATE:
T.ROBERTS DEC 08

ALL SOLEPLATES AT GROUND FLOOR LEVEL MUST HAVE A PRESERVATIVE TREATMENT IN ACCORDANCE WITH CURRENT STANDARDS



DPC SHOULD IDEALLY ALWAYS BE 150mm ABOVE THE EXTERNAL GROUND LEVEL. IN CASES WHERE THIS IS NOT POSSIBLE THIS DIMENSION CAN BE REDUCED TO A MINIMUM OF 75mm AS LONG AS THE CAVITY IS SUITABLY DRAINED, AS SHOWN ABOVE WITH A MINIMUM OF 225mm BETWEEN DPC AND DRAINAGE MEDIUM, WHERE THE SITE IS NOT SUBJECT TO A HIGH WATER TABLE OR WHERE THE CAVITY WILL NOT HAVE STANDING WATER. THE DETAILING OF THE CAVITY AND GROUND LEVELS ARE THE RESPONSIBILITY OF THE BUILDING DESIGNER AND NOT THE TIMBER FRAME DESIGNER. THIS DETAIL SHOULD BE CLEARED WITH THE BUILDING WARRANTOR WHERE USED.

WHERE THE GROUND IS LEVEL TO THE TOP OF SLAB THE DETAIL BELOW IS TO BE USED BUT AGAIN MUST BE CHECKED WITH BUILDING WARRANTOR AND FOUNDATION DESIGNER.

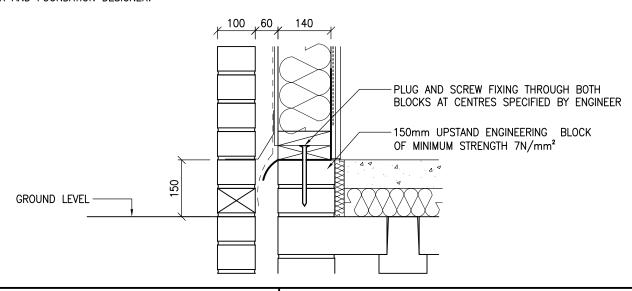




Building 1 Grosvenor Court Hipley Street Old Woking SURREY GU22 9LL

TEL: 01483 769518 FAX: 01483 770863

E-MAIL: design@silvatecdesign.com

DRAWING TITLE: EXTERNAL WALL — GROUND FLOOR

DRAWING No:	REVISION:	SCALE:
4.1	А	1:10
DRAWN BY:	DATE:	
T.KNIGHT	JAN 08	

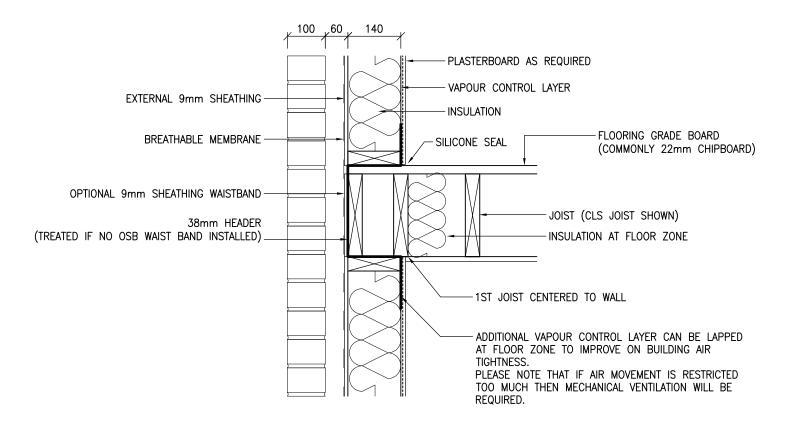



TEL: 01483 769518 FAX: 01483 770863

E-MAIL: design@silvatecdesign.com

DRAWING TITLE:

EXTERNAL WALL — INTERMEDIATE FLOOR


JOISTS PARALLEL

DRAWING No: REVISION: SCALE:

4.2 — 1:10

DRAWN BY: DATE:

T.KNIGHT JAN 08

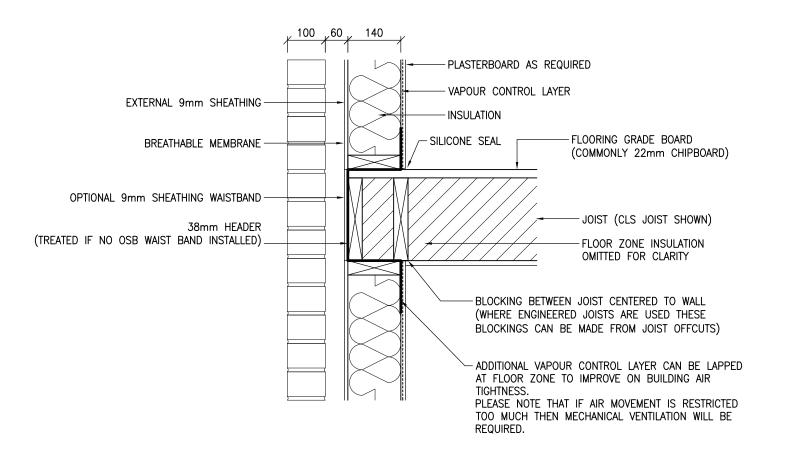




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TEL: 01483 769518 FAX: 01483 770863

EXTERNAL WALL — INTERMEDIATE FLOOR JOISTS PERPENDICULAR			
DRAWING No: 4.3		SCALE: 1:10	
DRAWN BY: T.KNIGHT	DATE: JAN 08		

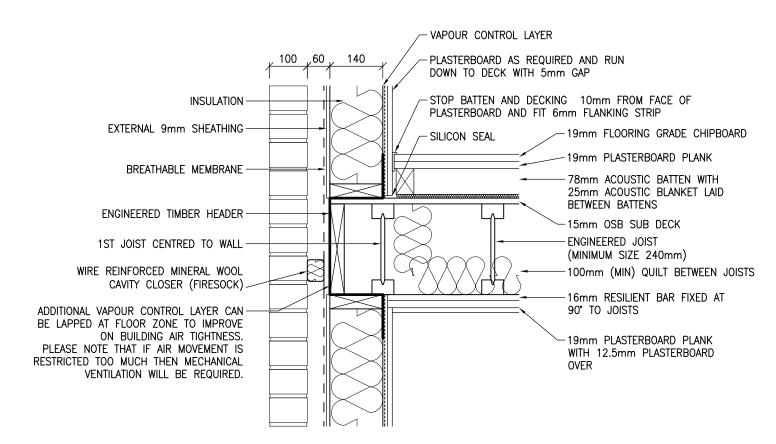

DETAILS SHOWN COMPLY TO E-FT-1 OF THE ROBUST STANDARD DETAILS. OTHER ACOUSTIC FLOOR DETAILS ARE AVAILABLE BUT MAY BE SUBJECT TO PRE-COMPLETION SOUND TESTING.



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TEL: 01483 769518 FAX: 01483 770863

E-MAIL: design@silvatecdesign.com

DRAWING TITLE:

EXTERNAL WALL — COMPARTMENT FLOOR


'I' JOISTS PARALLEL

DRAWING No: REVISION: SCALE:

4.4 — 1:10

DRAWN BY: DATE:

T.KNIGHT JAN 08

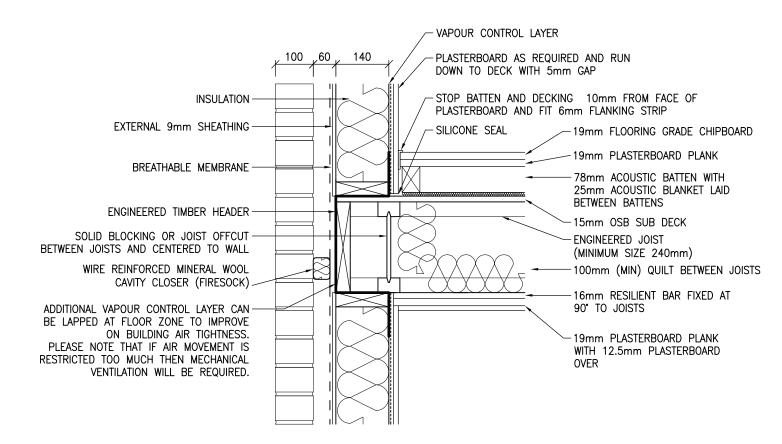

DETAILS SHOWN COMPLY TO E-FT-1 OF THE ROBUST STANDARD DETAILS. OTHER ACOUSTIC FLOOR DETAILS ARE AVAILABLE BUT MAY BE SUBJECT TO PRE-COMPLETION SOUND TESTING.



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TEL: 01483 769518 FAX: 01483 770863

E-MAIL: design@silvatecdesign.com

DRAWING TITLE:

EXTERNAL WALL — COMPARTMENT FLOOR


'I' JOISTS PERPENDICULAR

DRAWING No: REVISION: SCALE:

4.5 — 1:10

DRAWN BY: DATE:

T.KNIGHT JAN 08

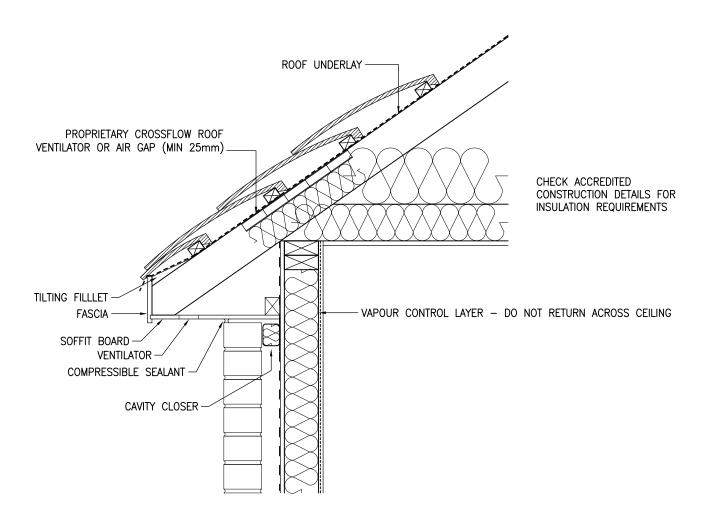




Building 1 Grosvenor Court
Hipley Street
Old Woking
SURREY GU22 9LL

TEL: 01483 769518 FAX: 01483 770863

E-MAIL: design@silvatecdesign.com

DRAWING TITLE: EXTERNAL WALL - CEILING AT EAVES

DRAWING No:	REVISION:	SCALE:
4.6	A	1:20
DRAWN BY:	DATE:	
T.KNIGHT	JAN 08	

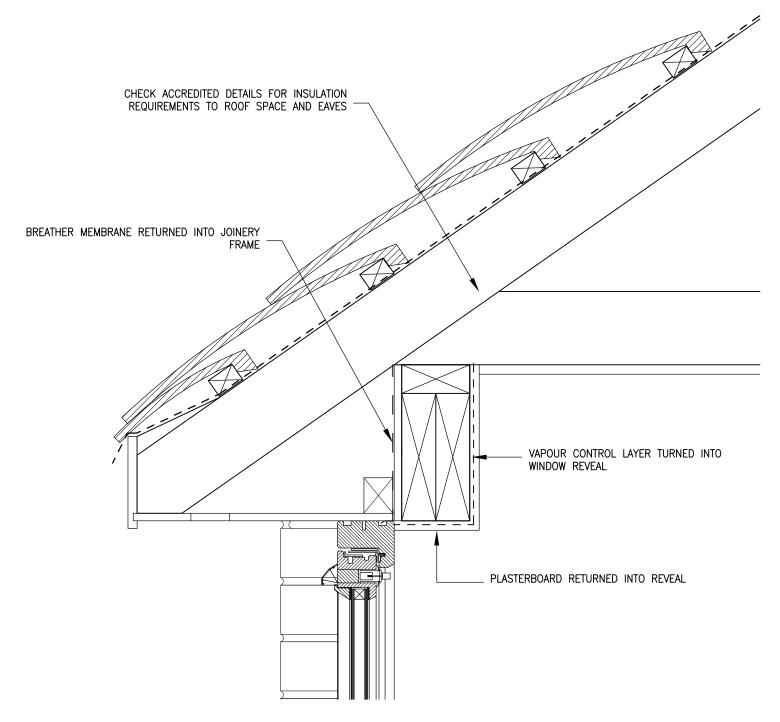

ENSURE WINDOW IS INSTALLED TIGHT AT THE HEAD WITH GAP AT BOTTOM OF WINDOW FRAME TO ALLOW FOR DIFFERENTIAL MOVEMENT DEPENDING UPON HEIGHT WITHIN BUILDING

WINDOW FRAME IS TO BE FIXED TO TIMBER FRAME WITH FRAME CRAMPS AND MUST REMAIN INDEPENDENT FROM MASONRY TO ALLOW FOR DIFFERENTIAL MOVEMENT



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TEL: 01483 769518 FAX: 01483 770863

E-MAIL: design@silvatecdesign.com

DRAWING TITLE:

EXTERNAL WALL


EAVES AT WINDOW HEAD

DRAWING No: REVISION: SCALE:

4.7 - 1:5

DRAWN BY: DATE:

T.KNIGHT JAN 08

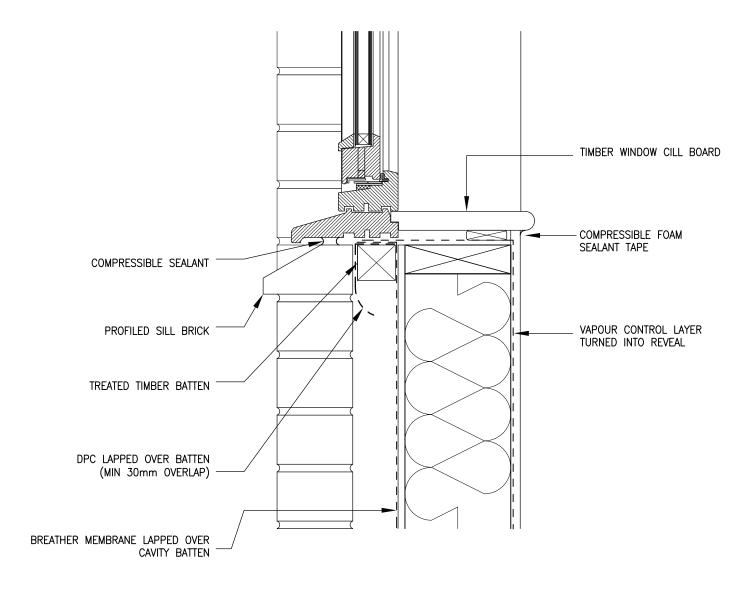

ENSURE WINDOW IS INSTALLED TIGHT AT THE HEAD WITH GAP AT BOTTOM OF WINDOW FRAME TO ALLOW FOR DIFFERENTIAL MOVEMENT DEPENDING UPON HEIGHT WITHIN BUILDING


WINDOW FRAME IS TO BE FIXED TO TIMBER FRAME WITH FRAME CRAMPS AND MUST REMAIN INDEPENDENT FROM MASONRY TO ALLOW FOR DIFFERENTIAL MOVEMENT



Building 1 Grosvenor Court Hipley Street Old Woking SURREY GU22 9LL

TEL: 01483 769518 FAX: 01483 770863

drawing title: EXTERNAL WALL — WINDOW CILL			
DRAWING No: 4.8	REVISION:	SCALE: 1:5	
DRAWN BY: DATE: T.KNIGHT JAN 08			

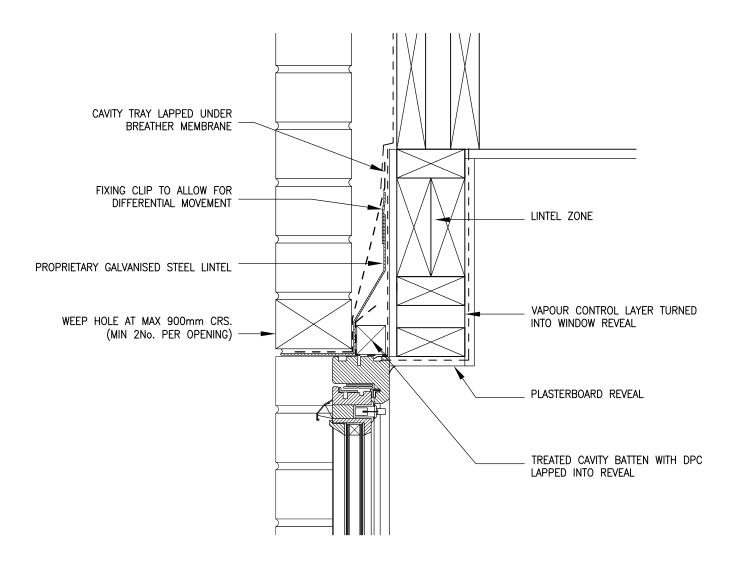

ENSURE WINDOW/DOOR IS INSTALLED TIGHT AT THE HEAD WITH GAP AT BOTTOM OF FRAME TO ALLOW FOR DIFFERENTIAL MOVEMENT DEPENDING UPON HEIGHT WITHIN BUILDING


JOINERY FRAME IS TO BE FIXED TO TIMBER FRAME WITH FRAME CRAMPS AND MUST REMAIN INDEPENDENT FROM MASONRY TO ALLOW FOR DIFFERENTIAL MOVEMENT




Building 1 Grosvenor Court Hipley Street Old Woking SURREY GU22 9LL


TEL: 01483 769518 FAX: 01483 770863

DRAWING TITLE:  EXTERNAL WALL — JOINERY HEAD		
DRAWING No: 4.9	REVISION: -	SCALE: 1:5
DRAWN BY: T.KNIGHT	DATE: JAN 08	

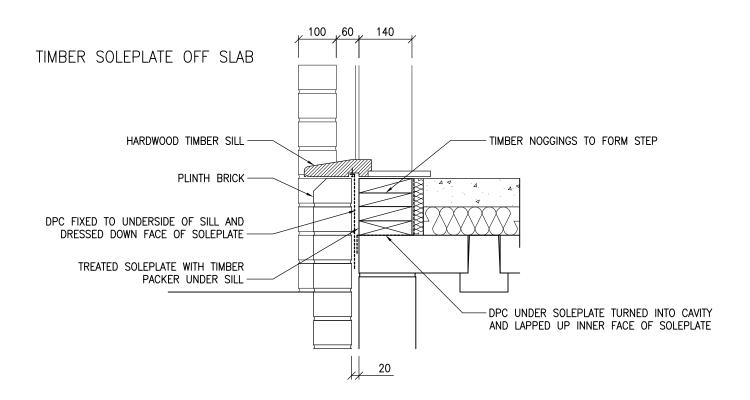

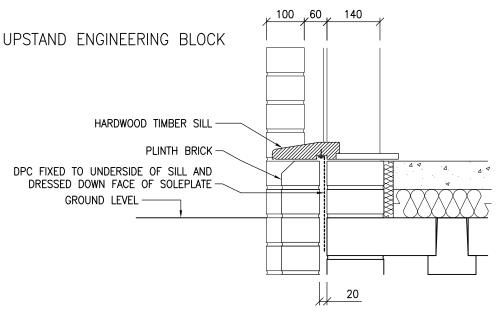

WHEN A FLUSH THRESHOLD IS REQUIRED ENSURE SUITABLE DRAINAGE IS ALLOWED FOR TO KEEP THE MOISTURE AWAY FROM ANY TIMBERS

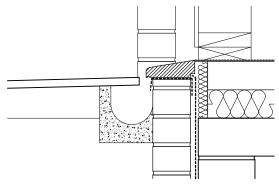




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DRAWING TITLE:		
EXTERNAL WALL —	DOOR	THRESHOLD

DRAWING No: 4.10		SCALE: 1:10
DRAWN BY:	DATE:	
T.KNIGHT	JAN 08	




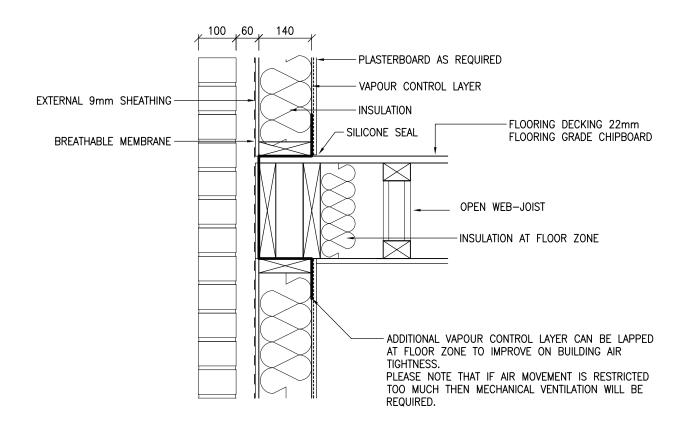

Building 1 Grosvenor Court Hipley Street Old Woking SURREY GU22 9LL

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DRAWING TITLE: INTERMEDIATE FLOOR OPEN WEB JOIST PARALLEL		
DRAWING No: 4.11	REVISION: A	SCALE: 1:10
DRAWN BY: T.KNIGHT	DATE: JUN 08	




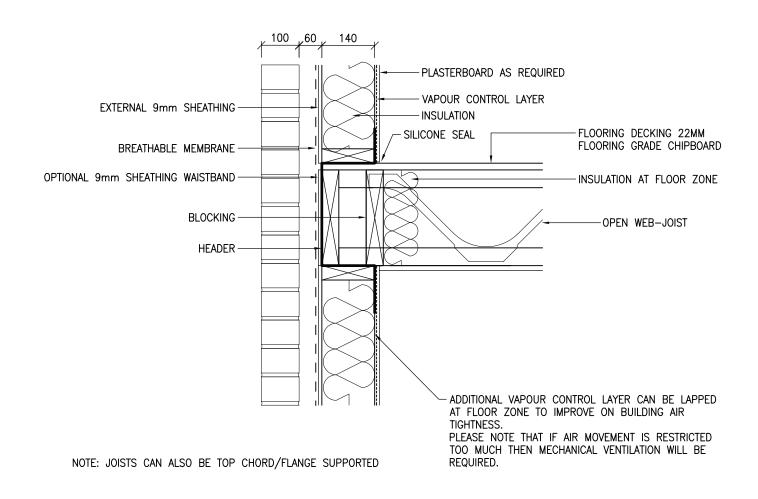

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TEL: 01483 769518 FAX: 01483 770863

DRAWING TITLE: INTERMEDIATE FLOOR OPEN WEB JOIST PERPENDICULAR			
DRAWING No: 4.12	REVISION: A	SCALE: 1:10	
DRAWN BY: T.KNIGHT	DATE: JUN 08		

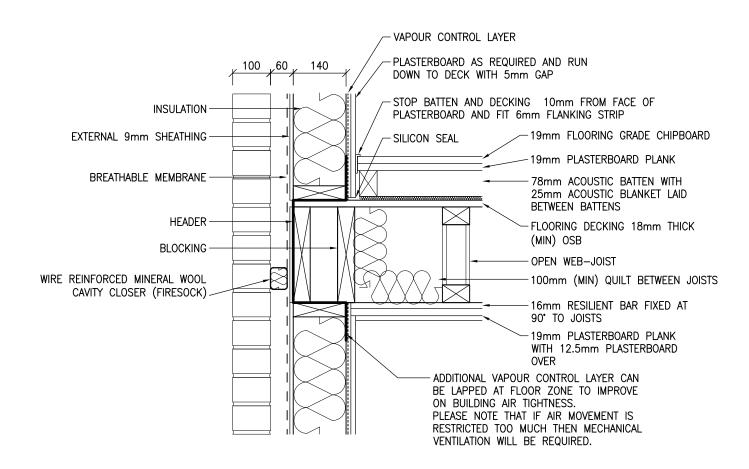


DETAILS SHOWN COMPLY TO E-FT-3 OF THE ROBUST STANDARD DETAILS. OTHER ACOUSTIC FLOOR DETAILS ARE AVAILABLE BUT MAY BE SUBJECT TO PRE-COMPLETION SOUND TESTING.



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TEL: 01483 769518 FAX: 01483 770863

DRAWING TITLE:  COMPARTMENT FLOOR  OPEN WEB JOIST PARALLEL			
DRAWING No: 4.13	REVISION: B	SCALE: 1:10	
DRAWN BY: T.KNIGHT	DATE: JUN 08		

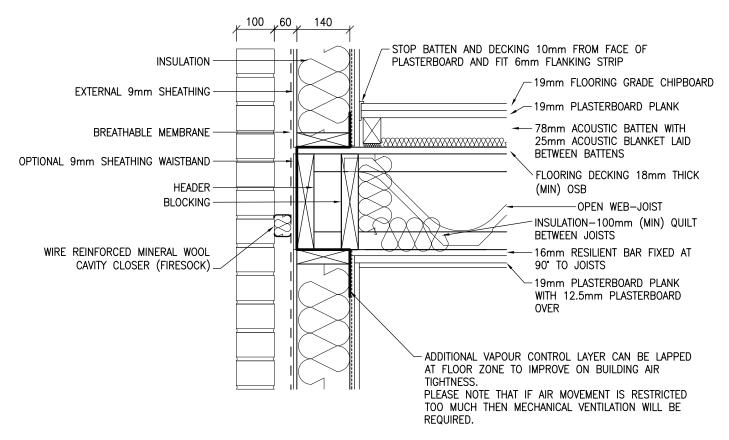


DETAILS SHOWN COMPLY TO E-FT-3 OF THE ROBUST STANDARD DETAILS. OTHER ACOUSTIC FLOOR DETAILS ARE AVAILABLE BUT MAY BE SUBJECT TO PRE-COMPLETION SOUND TESTING.



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TEL: 01483 769518 FAX: 01483 770863

DRAWING TITLE:				
	COMPARTMENT FLOOR			
OPEN WEB JOI	ST PERPENDICULAI	7		
DRAWING No:	REVISION:	SCALE:		
4.14	В	1:10		
DRAWN BY:	DATE:			
T.KNIGHT	JUN 08			

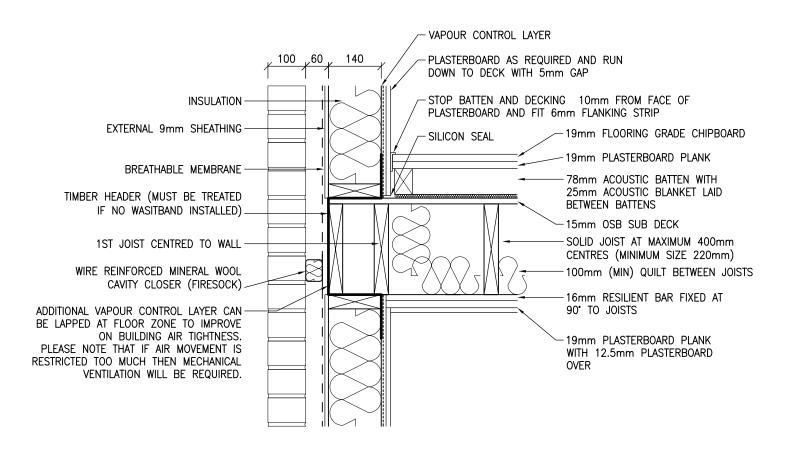

DETAILS SHOWN COMPLY TO E-FT-2 OF THE ROBUST STANDARD DETAILS. OTHER ACOUSTIC FLOOR DETAILS ARE AVAILABLE BUT MAY BE SUBJECT TO PRE-COMPLETION SOUND TESTING.



Building 1 Grosvenor Court Hipley Street Old Woking SURREY GU22 9LL

TEL: 01483 769518 FAX: 01483 770863

E-MAIL: design@silvatecdesign.com

DRAWING TITLE:

EXTERNAL WALL — COMPARTMENT FLOOR


SOLID JOISTS PARALLEL

DRAWING No: REVISION: SCALE:

4.15 — 1:10

DRAWN BY: DATE:

T.KNIGHT JAN 08

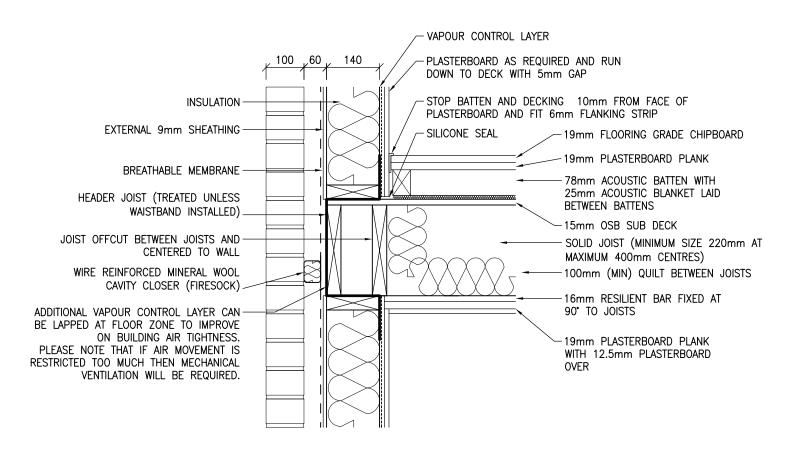

DETAILS SHOWN COMPLY TO E-FT-2 OF THE ROBUST STANDARD DETAILS. OTHER ACOUSTIC FLOOR DETAILS ARE AVAILABLE BUT MAY BE SUBJECT TO PRE-COMPLETION SOUND TESTING.



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TEL: 01483 769518 FAX: 01483 770863

E-MAIL: design@silvatecdesign.com

DRAWING TITLE:

EXTERNAL WALL — COMPARTMENT FLOOR


SOLID JOISTS PERPENDICULAR

DRAWING No: REVISION: SCALE:

4.16 — 1:10

DRAWN BY: DATE:

T.KNIGHT JAN 08

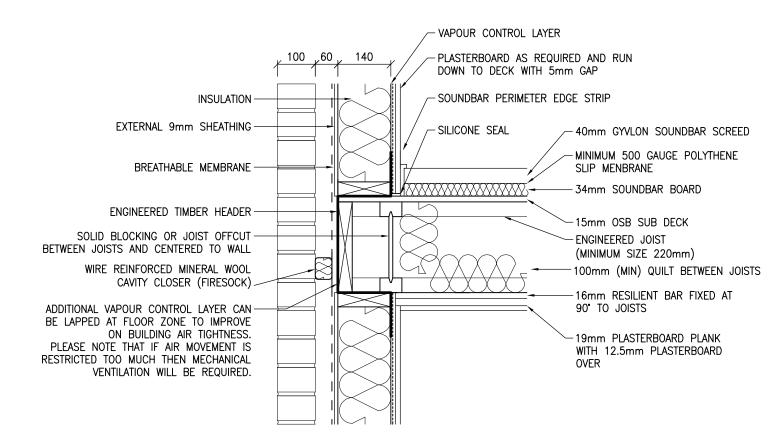

DETAILS SHOWN COMPLY TO E-FT-4 OF THE ROBUST STANDARD DETAILS. OTHER ACOUSTIC FLOOR DETAILS ARE AVAILABLE BUT MAY BE SUBJECT TO PRE-COMPLETION SOUND TESTING.



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DRAWING TITLE:

EXTERNAL WALL — COMPARTMENT FLOOR


WITH SCREED AND JOISTS PERPENDICULAR

DRAWING No: REVISION: SCALE:

4.17 — 1:10

DRAWN BY: DATE:

M.SINGLIAR NOV 08

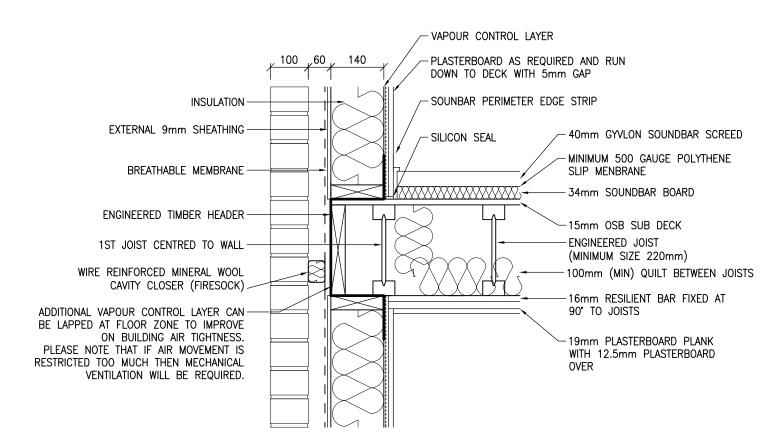

DETAILS SHOWN COMPLY TO E-FT-4 OF THE ROBUST STANDARD DETAILS. OTHER ACOUSTIC FLOOR DETAILS ARE AVAILABLE BUT MAY BE SUBJECT TO PRE-COMPLETION SOUND TESTING.



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DRAWING TITLE:

EXTERNAL WALL — COMPARTMENT FLOOR


WITH SCREED AND JOISTS PARALLEL

DRAWING No: REVISION: SCALE:

4.18 — 1:10

DRAWN BY: DATE:

M.SINGLIAR NOV 08

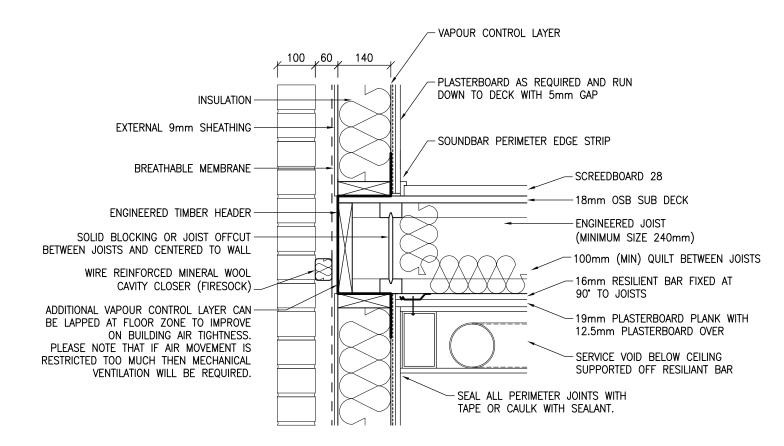

DETAILS SHOWN COMPLY TO E-FT-5 OF THE ROBUST STANDARD DETAILS. OTHER ACOUSTIC FLOOR DETAILS ARE AVAILABLE BUT MAY BE SUBJECT TO PRE-COMPLETION SOUND TESTING.

DRAWN BY:

T.ROBERTS



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TEL: 01483 769518 FAX: 01483 770863

E-MAIL: design@silvatecdesign.com

DRAWING TITLE:

EXTERNAL WALL — COMPARTMENT FLOOR


WITH SCREEDBOARD AND JOISTS PERPENDICULAR

DRAWING No: REVISION: SCALE:

4.19 — 1:10

DATE:

SEPT 09

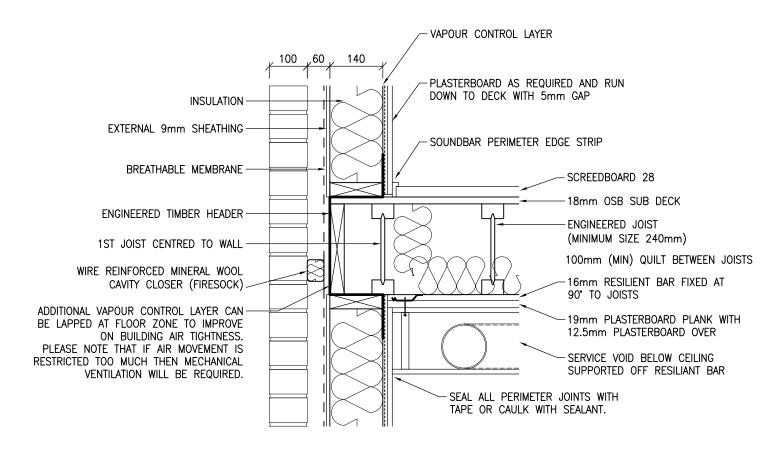

DETAILS SHOWN COMPLY TO E-FT-5 OF THE ROBUST STANDARD DETAILS. OTHER ACOUSTIC FLOOR DETAILS ARE AVAILABLE BUT MAY BE SUBJECT TO PRE-COMPLETION SOUND TESTING.



Building 1 Grosvenor Court Hipley Street Old Woking SURREY GU22 9LL

TEL: 01483 769518 FAX: 01483 770863

E-MAIL: design@silvatecdesign.com

DRAWING TITLE:

EXTERNAL WALL — COMPARTMENT FLOOR

WITH SCREEDBOARD AND JOISTS PARALLEL


DRAWING No: REVISION: SCALE:

4.20 — 1:10

DRAWN BY: DATE:


SEPT 09

T.ROBERTS

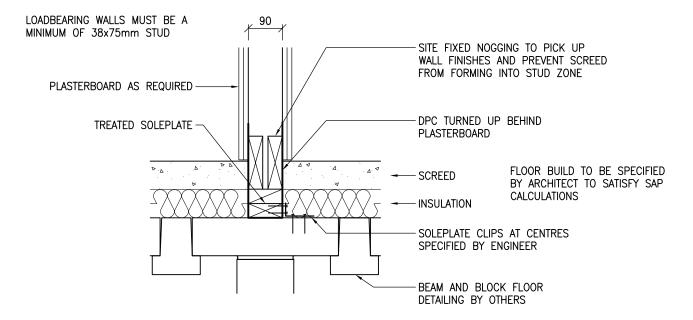

DPC SHOULD IDEALLY ALWAYS BE 150mm ABOVE THE EXTERNAL GROUND LEVEL. IN CASES WHERE THIS IS NOT POSSIBLE THIS DIMENSION CAN BE REDUCED TO A MINIMUM OF 75mm AS LONG AS THE CAVITY IS SUITABLY DRAINED AS SHOWN IN DETAIL 4.1 (EXTERNAL WALL — GROUND FLOOR). THE DETAILING OF THE CAVITY AND GROUND LEVELS ARE THE RESPONSIBILITY OF THE BUILDING DESIGNER AND NOT THE TIMBER FRAME DESIGNER. THIS DETAIL SHOULD BE CLEARED WITH BUILDING WARRANTOR WHERE USED.

WHERE THE GROUND IS LEVEL TO THE TOP OF SLAB THE DETAIL BELOW IS TO BE USED BUT AGAIN SHOULD BE CHECKED WITH BUILDING WARRANTOR AND FOUNDATION DESIGNER.

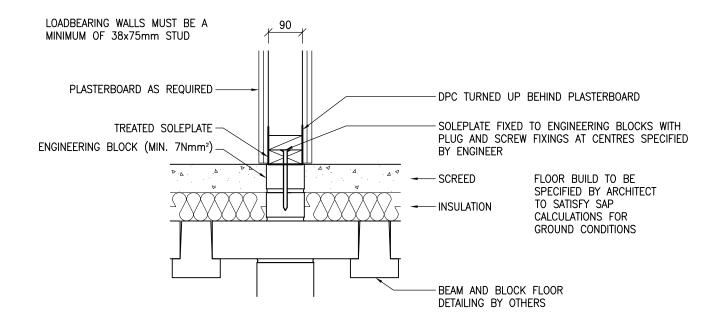




Building 1 Grosvenor Court Hipley Street Old Woking SURREY GU22 9LL


TEL: 01483 769518 FAX: 01483 770863

INTERNAL WALL — GF LOADBEARING			
DRAWING No: 5.1	REVISION: A	SCALE: 1:10	
	DATE: JAN 08		

ALL SOLEPLATES AT GROUND FLOOR LEVEL MUST HAVE A PRESERVATIVE TREATMENT IN ACCORDANCE WITH CURRENT STANDARDS

NON LOADBEARING WALLS CAN BE DESIGNED WITH 63mm STUD WALLS. IT IS RECOMMENDED THAT MID HEIGHT NOGGINGS ARE INSTALLED TO 63mm WALLS TO PROVIDE A MORE ROBUST FINISH ON SITE. SPECIAL CARE MUST BE TAKEN FOR PLASTERBOARD WHEN 63mm STUD IS TO BE USED FOR AN ACOUSTIC WALL INSIDE A DWELLING AS PER PART E OF THE BUILDING REGULATIONS.

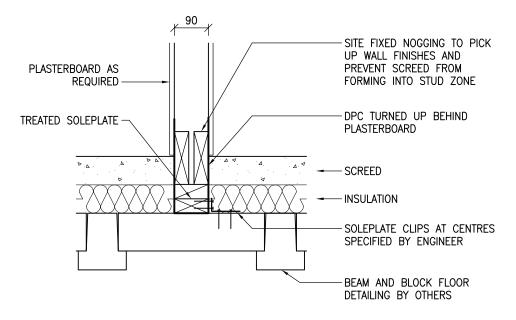


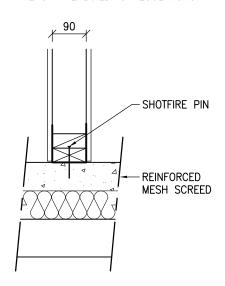

WHEN A REINFORCED MESH SCREED IS USED THE NON LOADBEARING PANELS MAY BE FIXED TO TOP OF FINISHED FLOOR. LOADING WILL BE APPROX 0.6kN/M AND MUST BE CHECKED WITH FLOOR SUPPLIER.

DPC SHOULD IDEALLY ALWAYS BE 150mm ABOVE THE EXTERNAL GROUND LEVEL. IN CASES WHERE THIS IS NOT POSSIBLE THIS DIMENSION CAN BE REDUCED TO A MINIMUM OF 75mm AS LONG AS THE CAVITY IS SUITABLY DRAINED AS SHOWN IN DETAIL 4.1 (EXTERNAL WALL — GROUND FLOOR). THE DETAILING OF THE CAVITY AND GROUND LEVELS ARE THE RESPONSIBILITY OF THE BUILDING DESIGNER AND NOT THE TIMBER FRAME DESIGNER. THIS DETAIL SHOULD BE CLEARED WITH BUILDING WARRANTOR WHERE USED.

WHERE THE GROUND IS LEVEL TO THE TOP OF SLAB THE DETAIL BELOW IS TO BE USED BUT AGAIN SHOULD BE CHECKED WITH BUILDING WARRANTOR AND FOUNDATION DESIGNER.

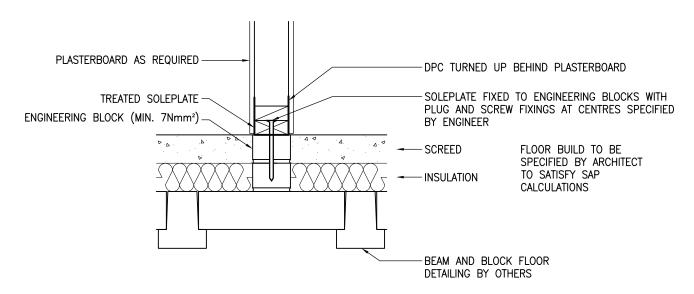




Building 1 Grosvenor Court Hipley Street Old Woking SURREY GU22 9LL

TEL: 01483 769518 FAX: 01483 770863

DRAWING TITLE: INTERNAL WALL — GF NON-LOADBEARING			
DRAWING No: 5.2	REVISION: A	SCALE: 1:10	
DRAWN BY: T.KNIGHT	DATE: JAN 08		

DETAIL SHOWN IS IN ACCORDANCE WITH ROBUST STANDARD DETAIL E-WT-1.
CAVITY TO BE MINIMUM 60mm BUT RECOMMEND A TOLERANCE IS ALLOWED FOR PLUMB OF PANEL DURING ERECTION,
ALTERNATIVELY FIX PANEL PLUMB TO WALL PANELS AS PER SILVATEC DETAIL 8.1.

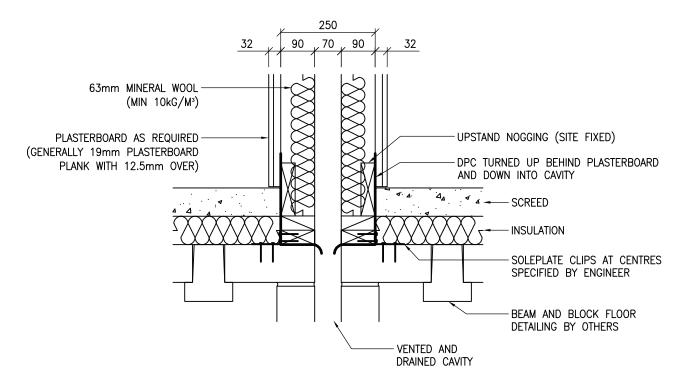

ALL SOLEPLATES AT GROUND FLOOR LEVEL MUST HAVE A PRESERVATIVE TREATMENT IN ACCORDANCE WITH CURRENT STANDARDS


ALL LOADBEARING WALLS WHICH ARE NOT PLASTERBOARDED ON BOTH SIDES AND HAVE NO SHEATHING TO THE CAVITY SIDE MUST HAVE MID HEIGHT NOGGINGS TO RESTRAIN STUDS FROM BUCKLING IN THE WEAK AXIS AS PER THE BRISTISH STANDARDS.




Building 1 Grosvenor Court Hipley Street Old Woking SURREY GU22 9LL

TEL: 01483 769518 FAX: 01483 770863

DRAWING TITLE: INTERNAL WALL — GF SEPARATING WALL			
DRAWING No: 5.3	REVISION: A	SCALE: 1:10	
DRAWN BY: T.KNIGHT	DATE: JAN 08		

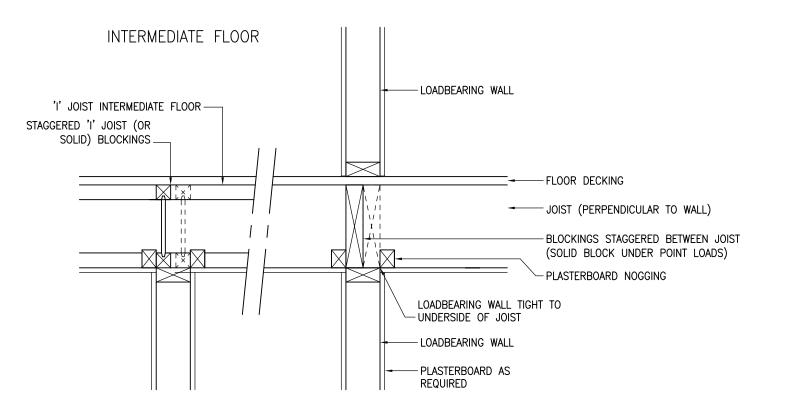

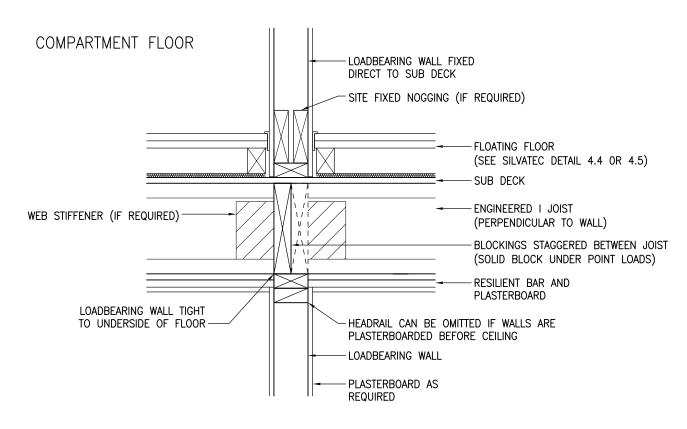



Building 1 Grosvenor Court Hipley Street Old Woking SURREY


TEL: 01483 769518 FAX: 01483 770863


E-MAIL: design@silvatecdesign.com

DRAWING TITLE:
INTERNAL WALL — UPPER FLOOR
LOADBEARING PARTITION

DRAWING No: REVISION: SCALE:
5.4 — 1:10

DRAWN BY: DATE:
T.KNIGHT JAN 08

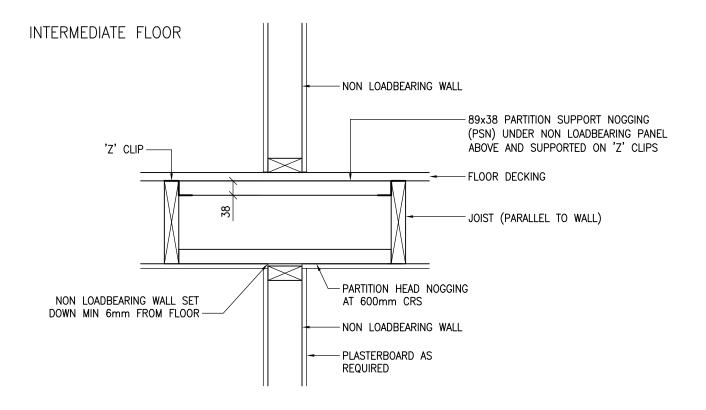

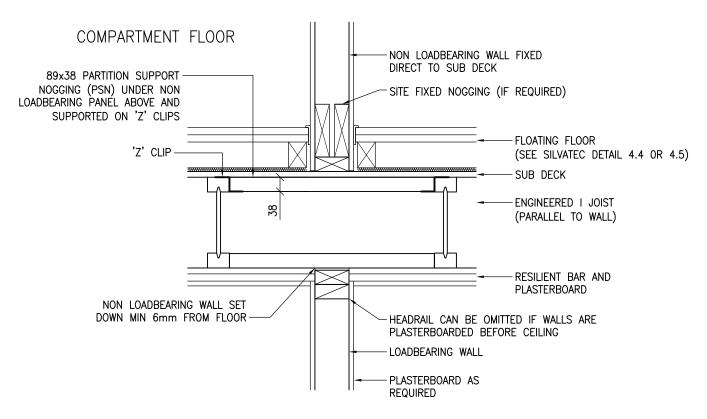


NON LOADBEARING WALLS CAN BE DESIGNED WITH 63mm STUD WALLS. IT IS RECOMMENDED THAT MID HEIGHT NOGGINGS ARE INSTALLED TO 63mm WALLS TO PROVIDE A MORE ROBUST FINISH ON SITE. SPECIAL CARE MUST BE TAKEN FOR PLASTERBOARD WHEN 63mm STUD IS TO BE USED FOR AN ACOUSTIC WALL INSIDE A DWELLING AS PER PART E OF THE BUILDING REGULATIONS.



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TEL: 01483 769518 FAX: 01483 770863

INTERNAL WALL — UPPER FLOOR NON LOADBEARING PARTITION					
DRAWING No: 5.5	REVISION: -	SCALE: 1:10			
	DATE: JAN 08				

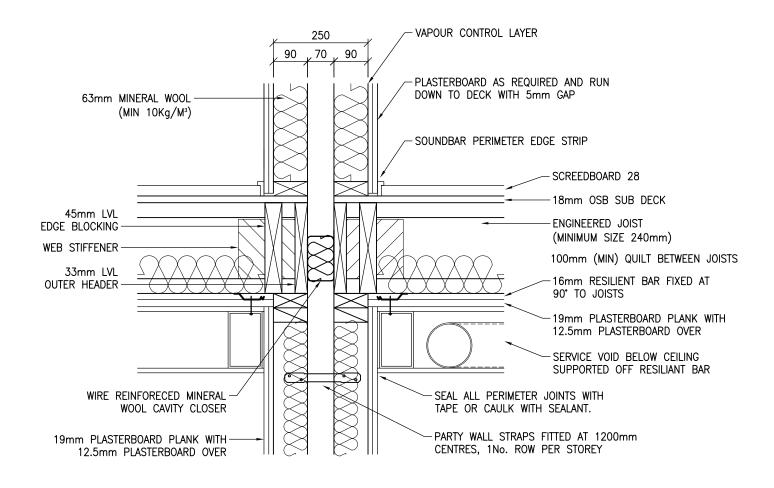

DETAILS SHOWN COMPLY TO E-FT-5 OF THE ROBUST STANDARD DETAILS. OTHER ACOUSTIC FLOOR DETAILS ARE AVAILABLE BUT MAY BE SUBJECT TO PRE-COMPLETION SOUND TESTING.

ALL LOADBEARING WALLS WHICH ARE NOT PLASTERBOARDED ON BOTH SIDES AND HAVE NO SHEATHING TO THE CAVITY SIDE MUST HAVE MID HEIGHT NOGGINGS TO RESTRAIN STUDS FROM BUCKLING IN THE WEAK AXIS AS PER THE BRISTISH STANDARDS.

T.ROBERTS



Building 1 Grosvenor Court Hipley Street Old Woking SURREY GU22 9LL

TEL: 01483 769518 FAX: 01483 770863

E-MAIL: design@silvatecdesign.com

DRAWING TITLE:


SEPARATING WALL — COMPARTMENT FLOOR
WITH SCREEDBOARD & JOISTS PERPENDICULAR

DRAWING No: REVISION: SCALE:

5.6.14 — 1:10

DRAWN BY: DATE:

SEPT 09

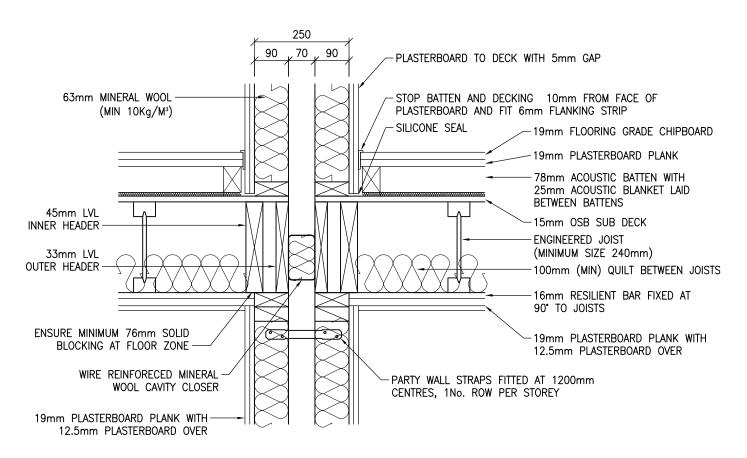

DETAILS SHOWN COMPLY TO E-FT-1 OF THE ROBUST STANDARD DETAILS. OTHER ACOUSTIC FLOOR DETAILS ARE AVAILABLE BUT MAY BE SUBJECT TO PRE-COMPLETION SOUND TESTING.


ALL LOADBEARING WALLS WHICH ARE NOT PLASTERBOARDED ON BOTH SIDES AND HAVE NO SHEATHING TO THE CAVITY SIDE MUST HAVE MID HEIGHT NOGGINGS TO RESTRAIN STUDS FROM BUCKLING IN THE WEAK AXIS AS PER THE BRISTISH STANDARDS.



Building 1 Grosvenor Court Hipley Street Old Woking SURREY GU22 9LL

TEL: 01483 769518 FAX: 01483 770863

DRAWING TITLE: INTERNAL WALL — SEPARATING WALL				
COMPARTMENT FLOOR JOISTS PARALLEL				
DRAWING No:	REVISION:	SCALE:		
5.6.1	А	1:10		
DRAWN BY:	DATE:			
T.KNIGHT	JAN 08			

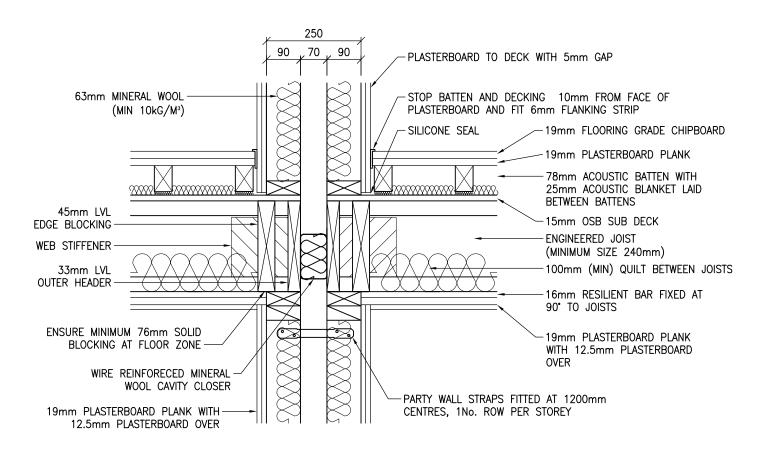

DETAILS SHOWN COMPLY TO E-FT-1 OF THE ROBUST STANDARD DETAILS. OTHER ACOUSTIC FLOOR DETAILS ARE AVAILABLE BUT MAY BE SUBJECT TO PRE-COMPLETION SOUND TESTING.

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T.KNIGHT



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TEL: 01483 769518 FAX: 01483 770863


E-MAIL: design@silvatecdesign.com

DRAWING TITLE:
INTERNAL WALL — SEPARATING WALL
COMPARTMENT FLOOR JOISTS PERPENDICULAR

DRAWING No: REVISION: SCALE:
5.6.2 A 1:10

DRAWN BY: DATE:

JAN 08

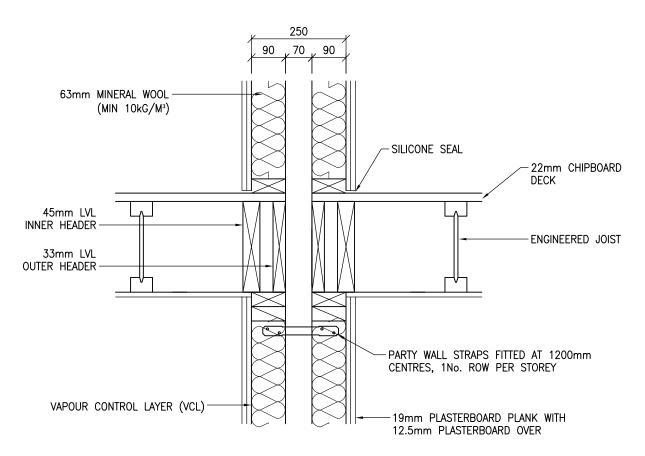

DETAILS SHOWN COMPLY TO E-WT-1 OF THE ROBUST STANDARD DETAILS. OTHER ACOUSTIC FLOOR DETAILS ARE AVAILABLE BUT MAY BE SUBJECT TO PRE-COMPLETION SOUND TESTING.


ALL LOADBEARING WALLS WHICH ARE NOT PLASTERBOARDED ON BOTH SIDES AND HAVE NO SHEATHING TO THE CAVITY SIDE MUST HAVE MID HEIGHT NOGGINGS TO RESTRAIN STUDS FROM BUCKLING IN THE WEAK AXIS AS PER THE BRISTISH STANDARDS.



Building 1 Grosvenor Court Hipley Street Old Woking SURREY GU22 9LL

TEL: 01483 769518 FAX: 01483 770863

DRAWING TITLE: INTERNAL WALL — SEPARATING WALL INTERMEDIATE FLOOR JOISTS PARALLEL				
DRAWING No: 5.6.3	REVISION: A	SCALE: 1:10		
DRAWN BY: T.KNIGHT	DATE: JAN 08			

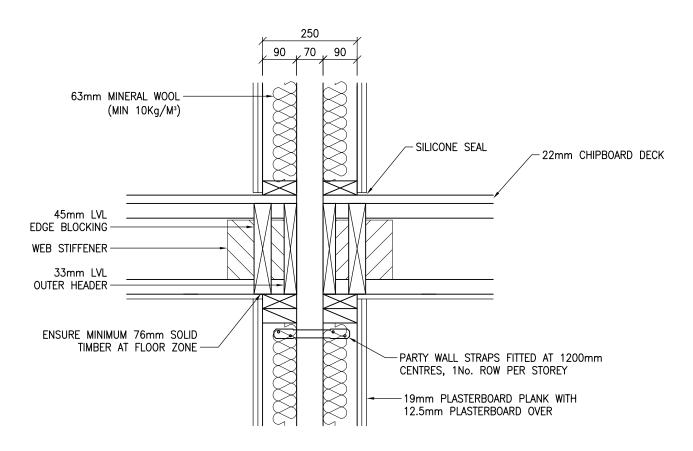

DETAILS SHOWN COMPLY TO E-WT-1 OF THE ROBUST STANDARD DETAILS. OTHER ACOUSTIC FLOOR DETAILS ARE AVAILABLE BUT MAY BE SUBJECT TO PRE-COMPLETION SOUND TESTING.

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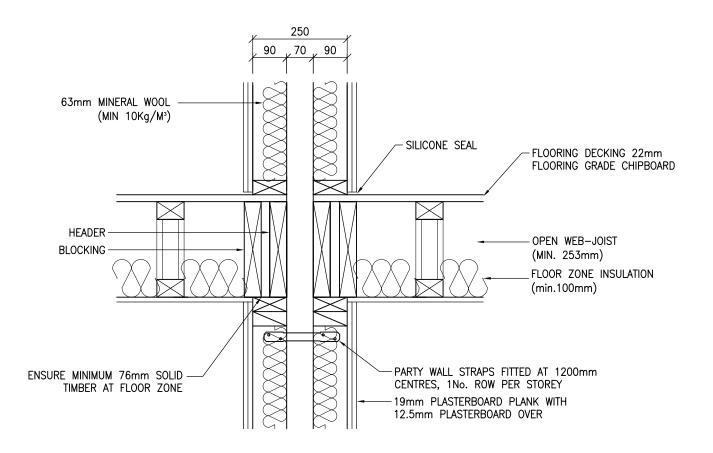
TEL: 01483 769518 FAX: 01483 770863

E-MAIL: design@silvatecdesign.com

DRAWING TITLE:
INTERNAL WALL — SEPARATING WALL
INTERMEDIATE FLOOR JOISTS PERPENDICULAR

DRAWING No: REVISION: SCALE:
5.6.4 A 1:10

DRAWN BY: DATE:
T.KNIGHT JAN 08



DETAILS SHOWN COMPLY TO E-WT-1 OF THE ROBUST STANDARD DETAILS. OTHER ACOUSTIC FLOOR DETAILS ARE AVAILABLE BUT MAY BE SUBJECT TO PRE-COMPLETION SOUND TESTING.


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Building 1 Grosvenor Court Hipley Street Old Woking SURREY GU22 9LL

TEL: 01483 769518 FAX: 01483 770863

DRAWING TITLE: INTERNAL WALL — SEPARATING WALL INTERMEDIATE FLOOR OPEN WEB PARALLEL				
DRAWING No: 5.6.5	REVISION: A	SCALE: 1:10		
DRAWN BY: T.KNIGHT	DATE: JUN 08			



DETAILS SHOWN COMPLY TO E-WT-1 OF THE ROBUST STANDARD DETAILS. OTHER ACOUSTIC FLOOR DETAILS ARE AVAILABLE BUT MAY BE SUBJECT TO PRE-COMPLETION SOUND TESTING.
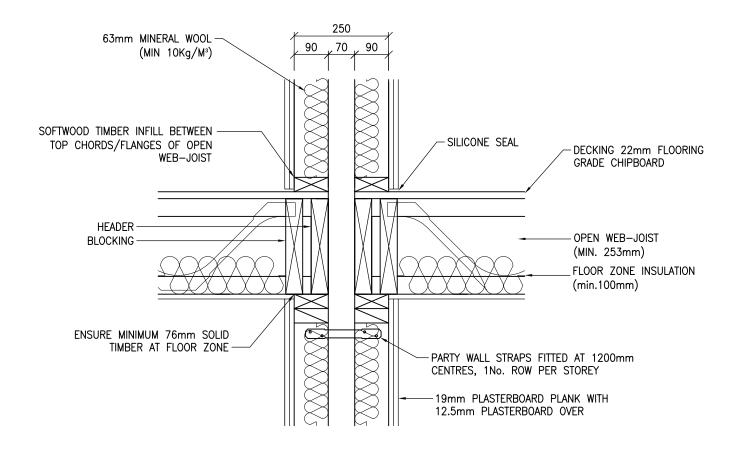
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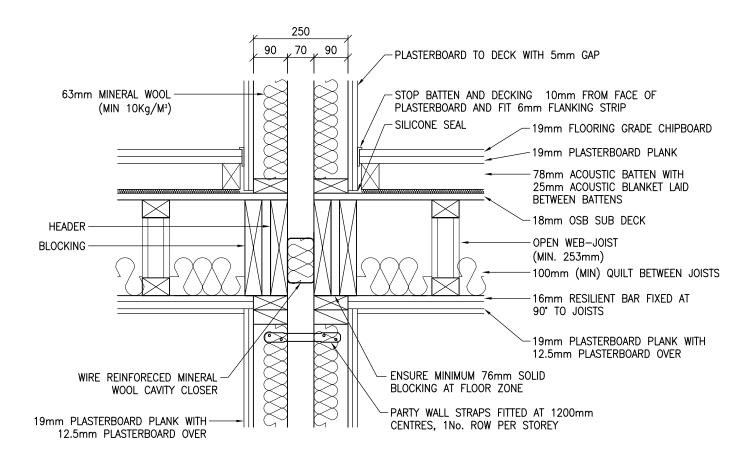
Building 1 Grosvenor Court Hipley Street Old Woking SURREY GU22 9LL

TEL: 01483 769518 FAX: 01483 770863

E-MAIL: design@silvatecdesign.com

DRAWING TITLE:
INTERNAL WALL — SEPARATING WALL
INTERMEDIATE FLOOR OPEN WEB PERPENDICULAR
DRAWING No: REVISION: SCALE:

DRAWN BY: DATE:
T.KNIGHT JUN 08



DETAILS SHOWN COMPLY TO E-FT-3 OF THE ROBUST STANDARD DETAILS. OTHER ACOUSTIC FLOOR DETAILS ARE AVAILABLE BUT MAY BE SUBJECT TO PRE-COMPLETION SOUND TESTING.

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Building 1 Grosvenor Court Hipley Street Old Woking SURREY GU22 9LL


TEL: 01483 769518 FAX: 01483 770863

E-MAIL: design@silvatecdesign.com

DRAWING TITLE:
INTERNAL WALL — SEPARATING WALL
COMPARTMENT FLOOR OPEN WEB PARALLEL

DRAWING No: REVISION: SCALE:
5.6.7 B 1:10

DRAWN BY: DATE:
T.KNIGHT JUN 08

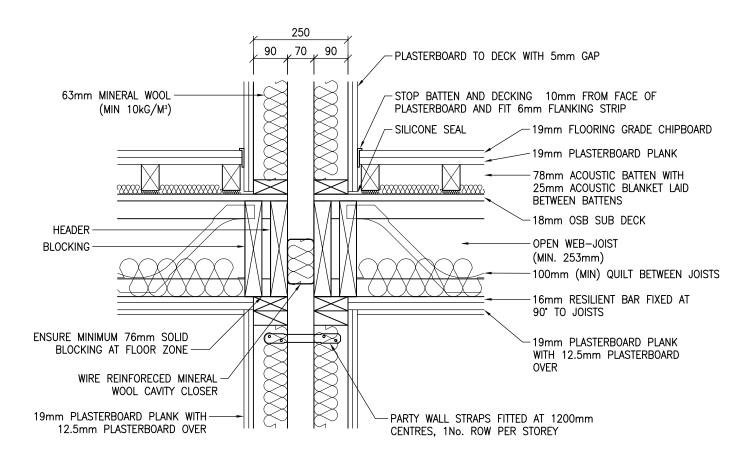

DETAILS SHOWN COMPLY TO E-FT-3 OF THE ROBUST STANDARD DETAILS. OTHER ACOUSTIC FLOOR DETAILS ARE AVAILABLE BUT MAY BE SUBJECT TO PRE-COMPLETION SOUND TESTING.

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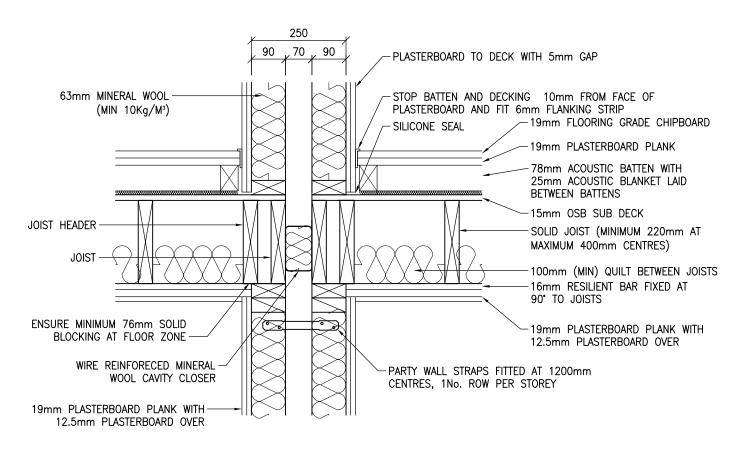
TEL: 01483 769518 FAX: 01483 770863

E-MAIL: design@silvatecdesign.com

DRAWING TITLE:
INTERNAL WALL — SEPARATING WALL
COMPARTMENT FLOOR OPEN WEB PERPENDICULAR
DRAWING No: REVISION: SCALE:
5.6.9 D. 1.10

5.6.8 B 1:10

DRAWN BY: DATE:
T.KNIGHT JUN 08



DETAILS SHOWN COMPLY TO E-FT-2 OF THE ROBUST STANDARD DETAILS. OTHER ACOUSTIC FLOOR DETAILS ARE AVAILABLE BUT MAY BE SUBJECT TO PRE-COMPLETION SOUND TESTING.

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TEL: 01483 769518 FAX: 01483 770863


E-MAIL: design@silvatecdesign.com

DRAWING TITLE:
SEPARATING WALL — COMPARTMENT FLOOR
SOLID JOISTS PARALLEL

DRAWING No: REVISION: SCALE:
5.6.0

5.6.9 — 1:10

DRAWN BY: DATE:
T.KNIGHT DEC 08

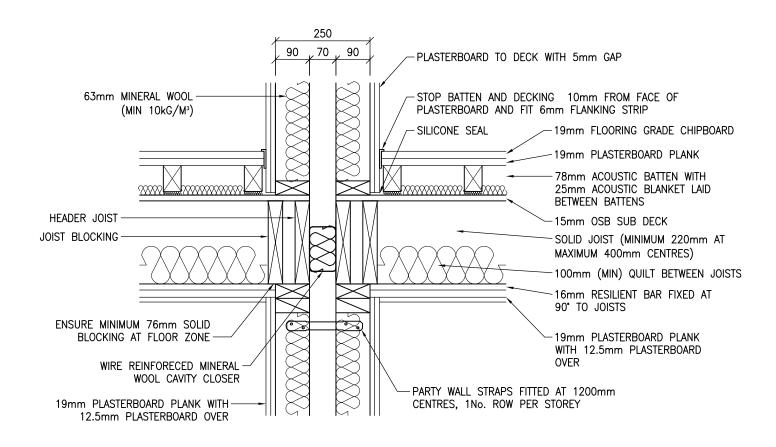

DETAILS SHOWN COMPLY TO E-FT-2 OF THE ROBUST STANDARD DETAILS. OTHER ACOUSTIC FLOOR DETAILS ARE AVAILABLE BUT MAY BE SUBJECT TO PRE-COMPLETION SOUND TESTING.

ALL LOADBEARING WALLS WHICH ARE NOT PLASTERBOARDED ON BOTH SIDES AND HAVE NO SHEATHING TO THE CAVITY SIDE MUST HAVE MID HEIGHT NOGGINGS TO RESTRAIN STUDS FROM BUCKLING IN THE WEAK AXIS AS PER THE BRISTISH STANDARDS.

T.KNIGHT



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TEL: 01483 769518 FAX: 01483 770863

E-MAIL: design@silvatecdesign.com

DRAWING TITLE:

SEPARATING WALL — COMPARTMENT FLOOR


SOLID JOISTS PERPENDICULAR

DRAWING No: REVISION: SCALE:

5.6.10 — 1:10

DRAWN BY: DATE:

DEC 08

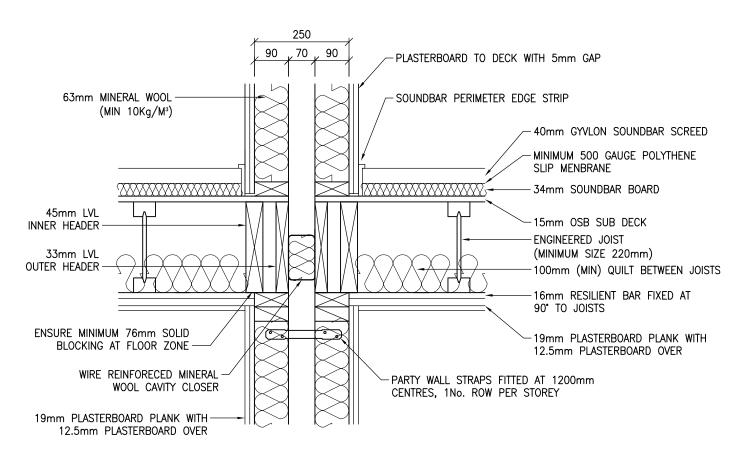

DETAILS SHOWN COMPLY TO E-FT-4 OF THE ROBUST STANDARD DETAILS. OTHER ACOUSTIC FLOOR DETAILS ARE AVAILABLE BUT MAY BE SUBJECT TO PRE-COMPLETION SOUND TESTING.

ALL LOADBEARING WALLS WHICH ARE NOT PLASTERBOARDED ON BOTH SIDES AND HAVE NO SHEATHING TO THE CAVITY SIDE MUST HAVE MID HEIGHT NOGGINGS TO RESTRAIN STUDS FROM BUCKLING IN THE WEAK AXIS AS PER THE BRISTISH STANDARDS.



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TEL: 01483 769518 FAX: 01483 770863

E-MAIL: design@silvatecdesign.com

DRAWING TITLE:

SEPARATING WALL — COMPARTMENT FLOOR


WITH SCREED AND JOISTS PARALLEL

DRAWING No: REVISION: SCALE:

5.6.11 — 1:10

DRAWN BY: DATE:

M.SINGLIAR NOV 08

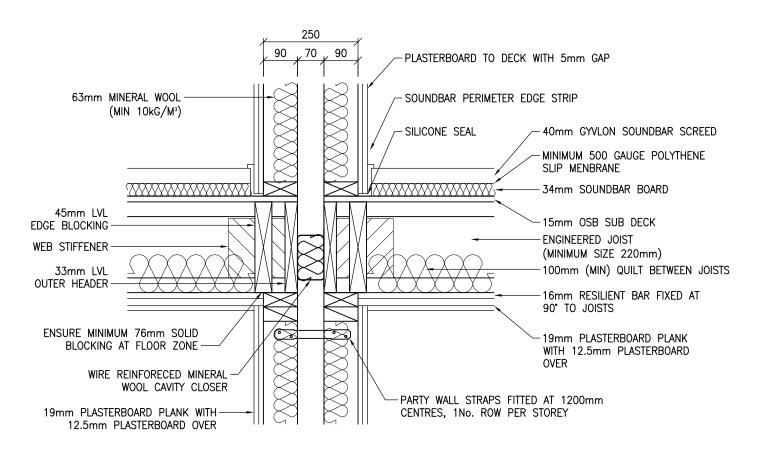

DETAILS SHOWN COMPLY TO E-FT-4 OF THE ROBUST STANDARD DETAILS. OTHER ACOUSTIC FLOOR DETAILS ARE AVAILABLE BUT MAY BE SUBJECT TO PRE-COMPLETION SOUND TESTING.

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M.SINGLIAR



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TEL: 01483 769518 FAX: 01483 770863

E-MAIL: design@silvatecdesign.com

DRAWING TITLE:


SEPARATING WALL — COMPARTMENT FLOOR
WITH SCREED AND JOISTS PERPENDICULAR

DRAWING No: REVISION: SCALE:

5.6.12 — 1:10

DRAWN BY: DATE:

80 VON

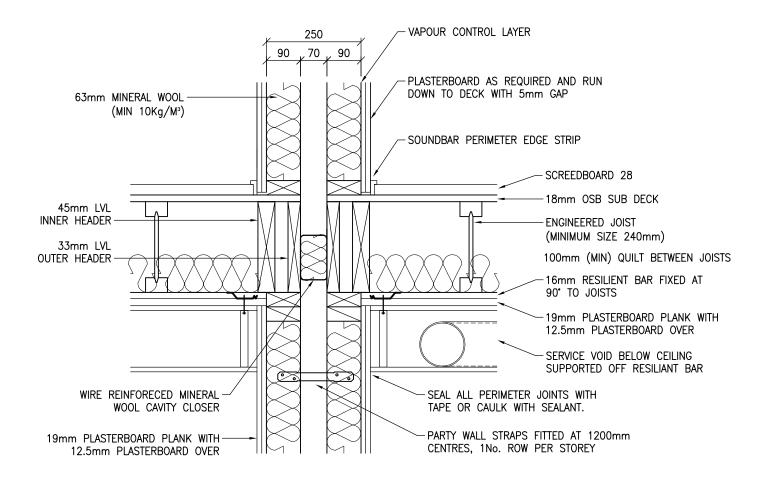

DETAILS SHOWN COMPLY TO E-FT-5 OF THE ROBUST STANDARD DETAILS. OTHER ACOUSTIC FLOOR DETAILS ARE AVAILABLE BUT MAY BE SUBJECT TO PRE-COMPLETION SOUND TESTING.

ALL LOADBEARING WALLS WHICH ARE NOT PLASTERBOARDED ON BOTH SIDES AND HAVE NO SHEATHING TO THE CAVITY SIDE MUST HAVE MID HEIGHT NOGGINGS TO RESTRAIN STUDS FROM BUCKLING IN THE WEAK AXIS AS PER THE BRISTISH STANDARDS.



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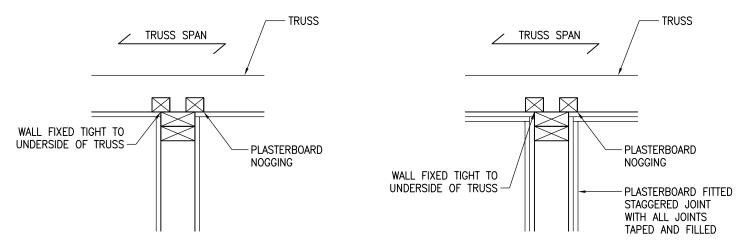
E-MAIL: design@silvatecdesign.com

DRAWING TITLE:
SEPARATING WALL — COMPARTMENT FLOOR
WITH SCREEDBOARD AND JOISTS PARALLEL
DRAWING No: REVISION: SCALE:
5.6.13 — 1:10

DRAWN BY: DATE:
T.ROBERTS SEPT 09


# LOADBEARING WALL 30 MINUTES FIRE RESISTANCE

# LOADBEARING WALL 60 MINUTES FIRE RESISTANCE



PLASTERBOARD REQUIREMENTS MUST BE CONFIRMED WITH BUILDING DESIGNER

#### NON LOADBEARING WALL 30 MINUTES FIRE RESISTANCE

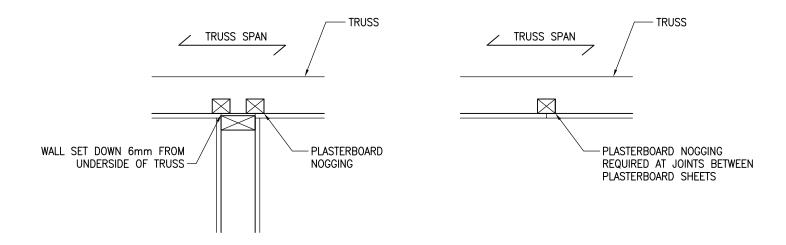

ALL PLASTERBOARD SHOWN IS 12.5mm THICK AND MUST BE MINIMUM OF 10Kg/M2.

PLASTERBOARD MUST BE FIXED IN ACCORDANCE WITH MANUFACTURERS INSTRUCTIONS, WITH JOINTS TAPED AND FILLED AND BACKED BY SOLID TIMBER.


ENSURE PLASTERBOARD SCREWS DO NOT PENETRATE PAPER AS THIS WILL COMPROMISE THE INTEGRITY OF THE PLASTERBOARD



Building 1 Grosvenor Court Hipley Street Old Woking SURREY GU22 9LL

TEL: 01483 769518 FAX: 01483 770863

DRAWING TITLE:	WALL —	CEILING
DRAWING No: 5.7	REVISION: -	SCALE: 1:10
DRAWN BY: T.KNIGHT	DATE: JAN 08	

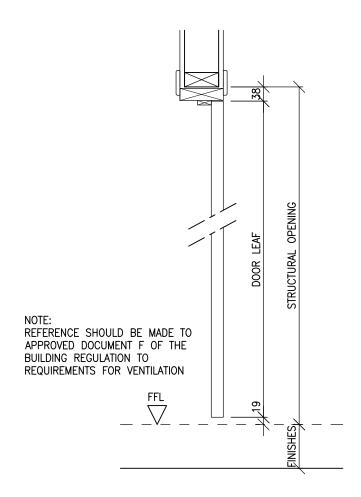


#### IMPERIAL DOOR LEAF SIZES

DOOR LEAF WIDTH	HEIGHT	STRUCTURAL OPEI WIDTH HE	NING FROM FFL IGHT
381 (1'3")	1981 (6'6")	457 203	8 (ALLOW 2040)
457 (1'6")	1981 (6'6")	533 203	8 (ALLOW 2040)
533 (1'9")	1981 (6'6")	610 203	8 (ALLOW 2040)
610 (2'0")	1981 (6'6")	686 203	8 (ALLOW 2040)
686 (2'3")	1981 (6'6")	762 203	8 (ALLOW 2040)
762 (2'6")	1981 (6'6")	838 203	8 (ALLOW 2040)
838 (2'9")	1981 (6'6")	914 203	8 (ALLOW 2040)

#### METRIC DOOR LEAF SIZES

DOOR LEAF WIDTH	HEIGHT	STRUCTURAL WIDTH	OPENING FROM FFL HEIGHT
526	2040	600	2097 (ALLOW 2100)
626	2040	700	2097 (ALLOW 2100)
726	2040	800	2097 (ALLOW 2100)
826	2040	900	2097 (ALLOW 2100)
926	2040	1000	2097 (ALLOW 2100)

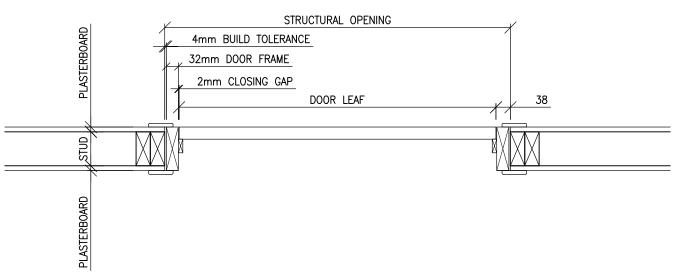




Building 1 Grosvenor Court Hipley Street Old Woking SURREY GU22 9LL

TEL: 01483 769518 FAX: 01483 770863

drawing title: DOOR LININGS — INTERNAL					
DRAWING No: 6.1	REVISION: -	SCALE: 1:20			
DRAWN BY: T.KNIGHT	DATE: JAN 08				

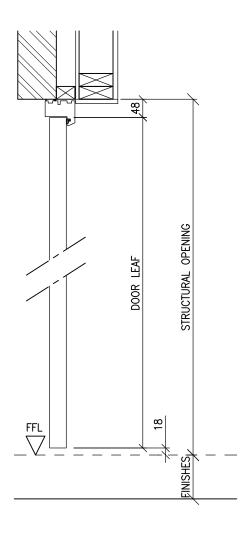


#### IMPERIAL DOOR LEAF SIZES

DOOR LEAF WIDTH	HEIGHT	STRUCTURAL OPENING FROM FFL WIDTH HEIGHT
381 (1'3")	1981 (6'6")	477 2077 (ALLOW 2100)
457 (1'6")	1981 (6'6")	553 2077 (ALLOW 2100)
533 (1'9")	1981 (6'6")	629 2077 (ALLOW 2100)
610 (2'0")	1981 (6'6")	706 2077 (ALLOW 2100)
686 (2'3")	1981 (6'6")	782 2077 (ALLOW 2100)
762 (2'6")	1981 (6'6")	858 2077 (ALLOW 2100)
838 (2'9")	1981 (6'6")	934 2077 (ALLOW 2100)
914 (3'0")	1981 (6'6")	981 2077 (ALLOW 2100)

#### METRIC DOOR LEAF SIZES

DOOR LEAF WIDTH	HEIGHT	STRUCTURAL OPENING FROM FFL WIDTH HEIGHT
526	2040	622 2107 (ALLOW 2100)
626	2040	722 2107 (ALLOW 2100)
726	2040	822 2107 (ALLOW 2100)
826	2040	922 2107 (ALLOW 2100)
926	2040	1022 2107 (ALLOW 2100)

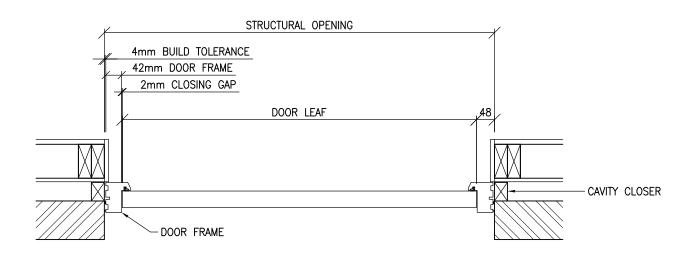



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TEL: 01483 769518 FAX: 01483 770863

E-MAIL: design@silvatecdesign.com


DRAWING		INICC		ΓVΤΙ	ERNAL	\ <i>\                                   </i>
				ΕΧΙΙ	TRIVAL	WALL
DRAWING	No:	<b>REVISIO</b>	N:		SCALE:	

DRAWING NO: REVISION: SCALE:

6.2 - 1:20

DRAWN BY: DATE:

T.KNIGHT JAN 08

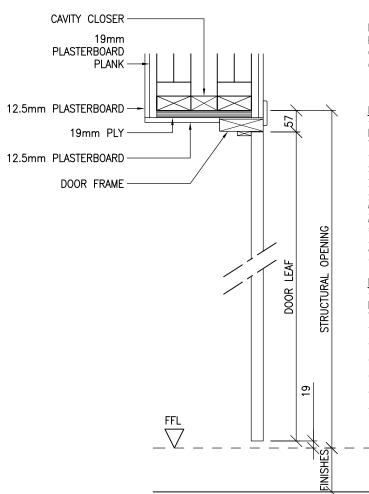


NOTE: PART B - 10.6 STATES THAT CAVITY BARRIERS AROUND OPENINGS CAN BE FORMED BY THE DOOR FRAME. CHECK SPECIFICATION WITH DOOR SUPPLIER.

#### IMPERIAL DOOR LEAF SIZES

DOOR LEAF WIDTH	HEIGHT	STRUCTUR. WIDTH	AL OPENING F HEIGHT	ROM FFL
381 (1'3")	1981 (6'6")	457	2057	
457 (1'6")	1981 (6'6")	533	2057	
533 (1'9")	1981 (6'6")	610	2057	
610 (2'0")	1981 (6'6")	686	2057	
686 (2'3")	1981 (6'6")	762	2057	
762 (2'6")	1981 (6'6")	838	2057	
838 (2'9")	1981 (6'6")	914	2057	

#### METRIC DOOR LEAF SIZES

DOOR LEAF WIDTH	HEIGHT	STRUCTURAL WIDTH	OPENING FROM FFL HEIGHT
526	2040	600	2116
626	2040	700	2116
726	2040	800	2116
826	2040	900	2116
926	2040	1000	2116

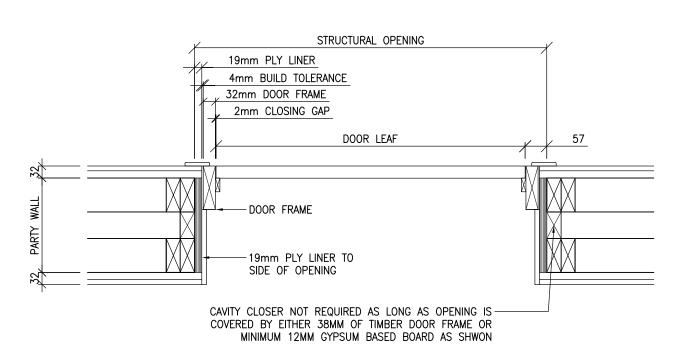




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# DRAWING TITLE: DOOR LININGS — PARTY WALL DRAWING No: REVISION: SCALE: 6.3 — 1:20 DRAWN BY: DATE: T.KNIGHT JAN 08






TEL: 01483 769518 FAX: 01483 770863


E-MAIL: design@silvatecdesign.com

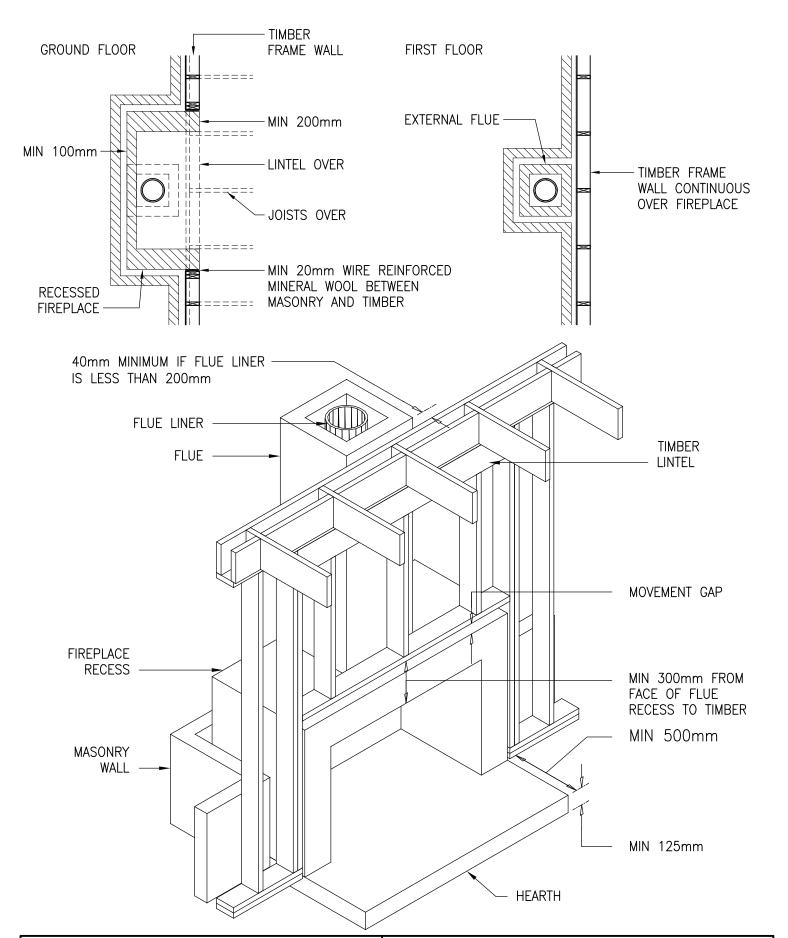DRAWING TITLE:
SERVICES — CHIMNEY EXTERNAL

DRAWING No: REVISION: SCALE:
7.1 - 1:40

DRAWN BY: DATE:
T.KNIGHT JAN 08

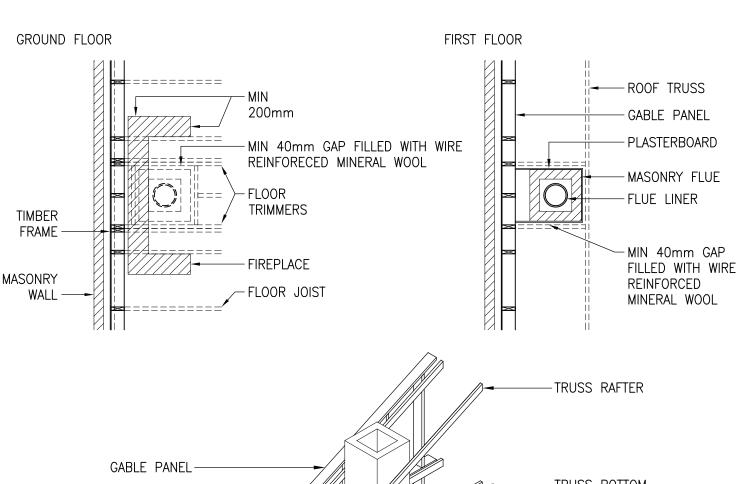

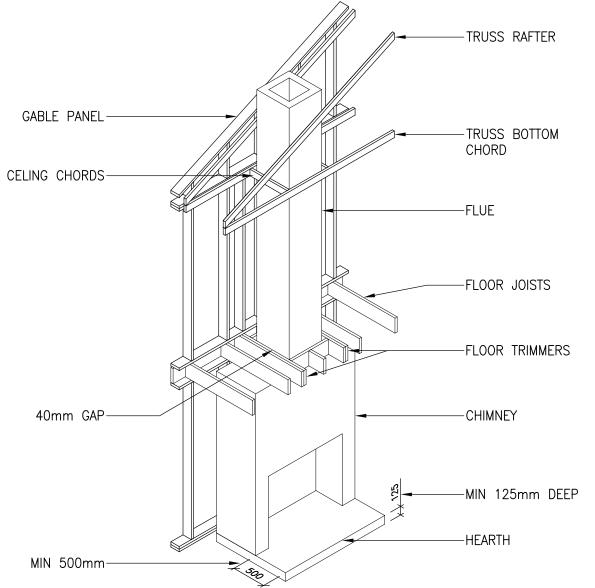



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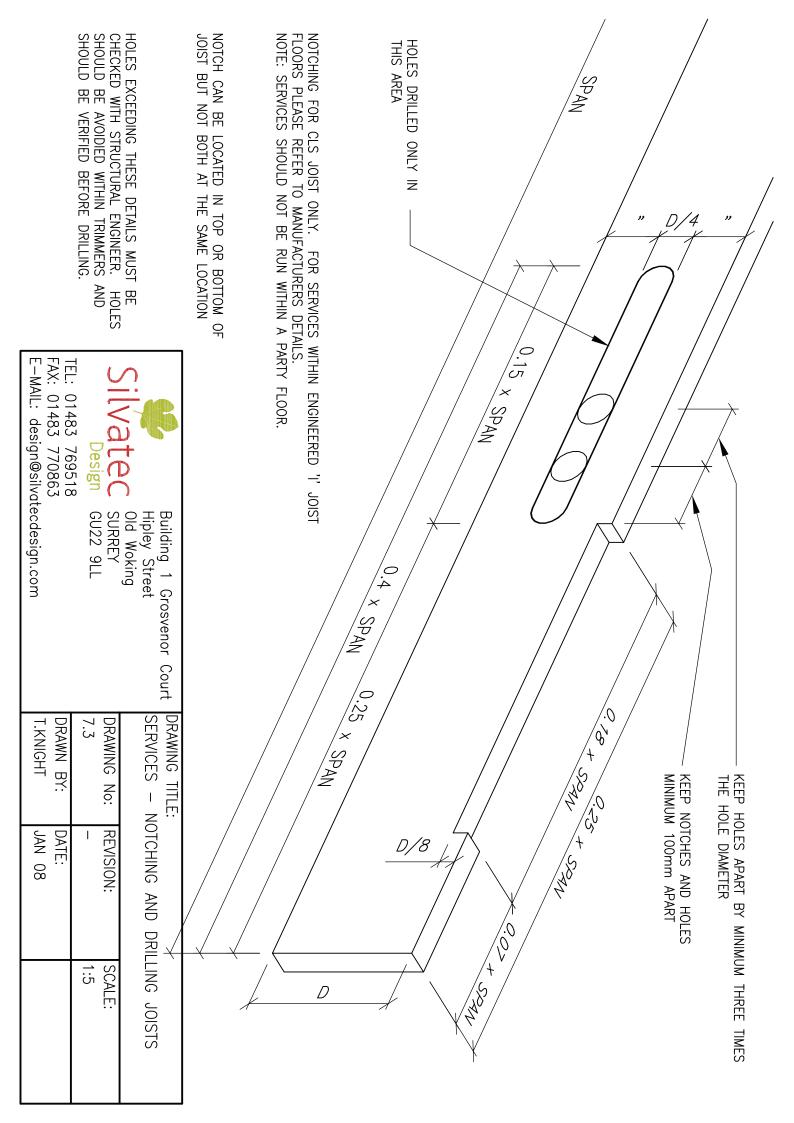
E-MAIL: design@silvatecdesign.com


DRAWING TITLE:

SERVICES - CHIMNEY INTERNAL

DRAWING No: REVISION: SCALE:
7.2 - 1:40

DRAWN BY: DATE:
T.KNIGHT JAN 08



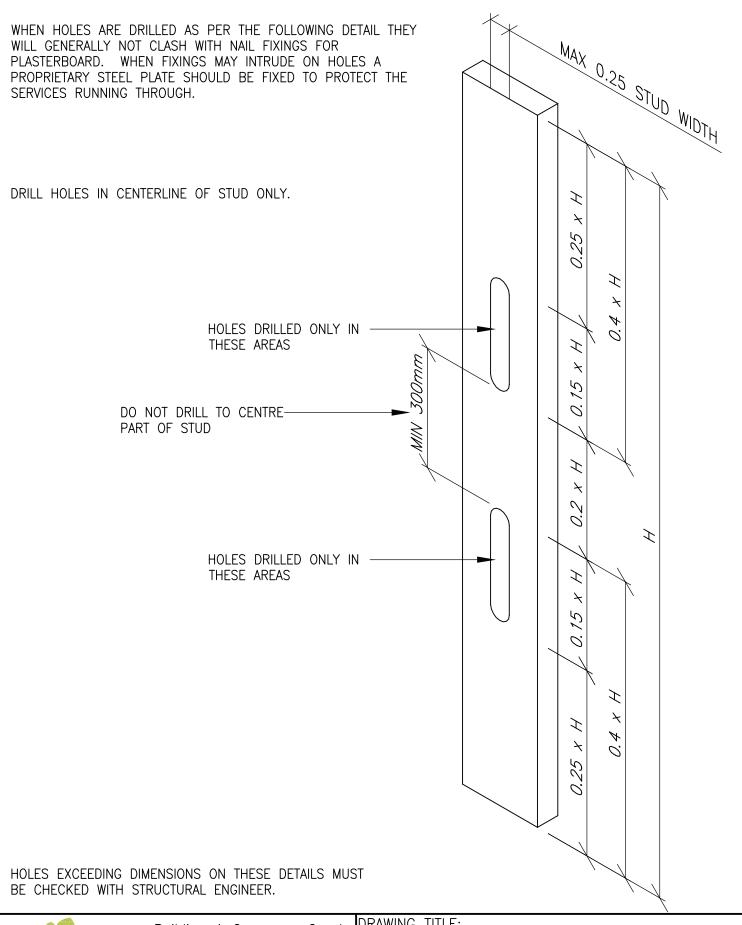




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DRAWING	1111	⊏.				
SERVICE	S	_	NOTCHING	AND	DRILLING	STUD:

DRAWING No:	REVISION:	SCALE:
7.4	_	1:5
DRAWN BY:	DATE:	
T.KNIGHT	JAN 08	



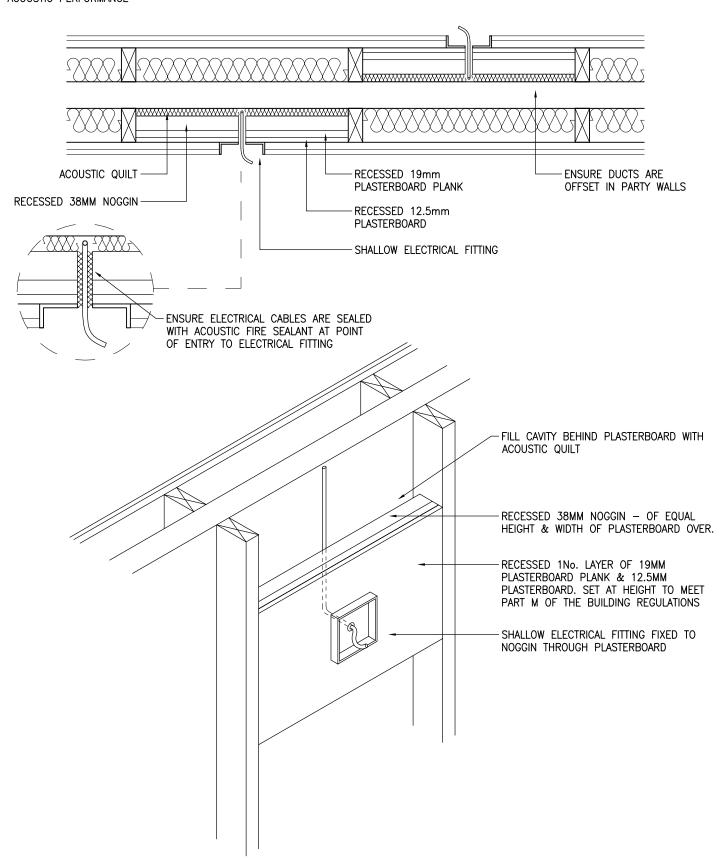

TEL: 01483 769518 FAX: 01483 770863

E-MAIL: design@silvatecdesign.com

DRAWING TITLE:

SERVICES — ELECTRICAL SOCKETS IN


SEPARATING WALLS (SHALLOW FITTING)

DRAWING No: REVISION: SCALE:

7.5 — 1:10

DRAWN BY: DATE:

T.ROBERTS AUG 09

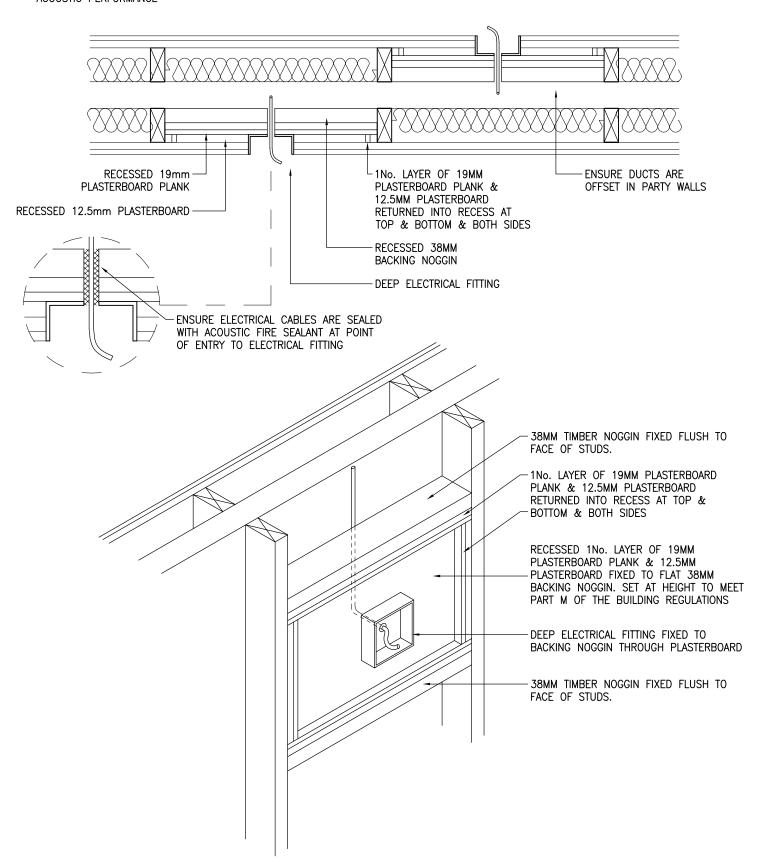




TEL: 01483 769518 FAX: 01483 770863

DRAWING TITLE: SERVICES — ELECTRICAL SOCKETS IN SEPARATING WALLS (DEEP FITTING)				
DRAWING No:	REVISION:	SCALE:		
7.6	_	1:10		
DRAWN BY:	DATE:			
T.ROBERTS	AUG 09			

WHEN INSTALLING SERVICES IN PARTY FLOORS CARE MUST BE TAKEN TO MAINTAIN BOTH ACOUSTIC AND FIRE INTEGRITY OF THE FLOOR.

THE FOLLOWING DETAIL IS A GUIDE ONLY AND REFERENCE MUST BE MADE TO THE APPROVED DOCUMENT PART B FOR ALL FIRE ISSUES INCLUDING MAXIMUM PENETRATION SIZES.

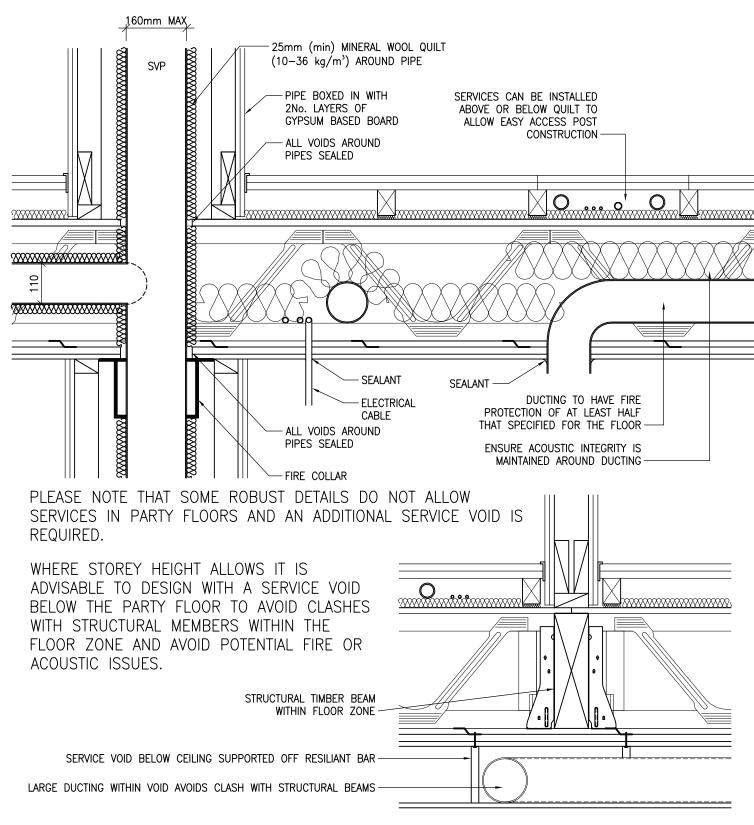



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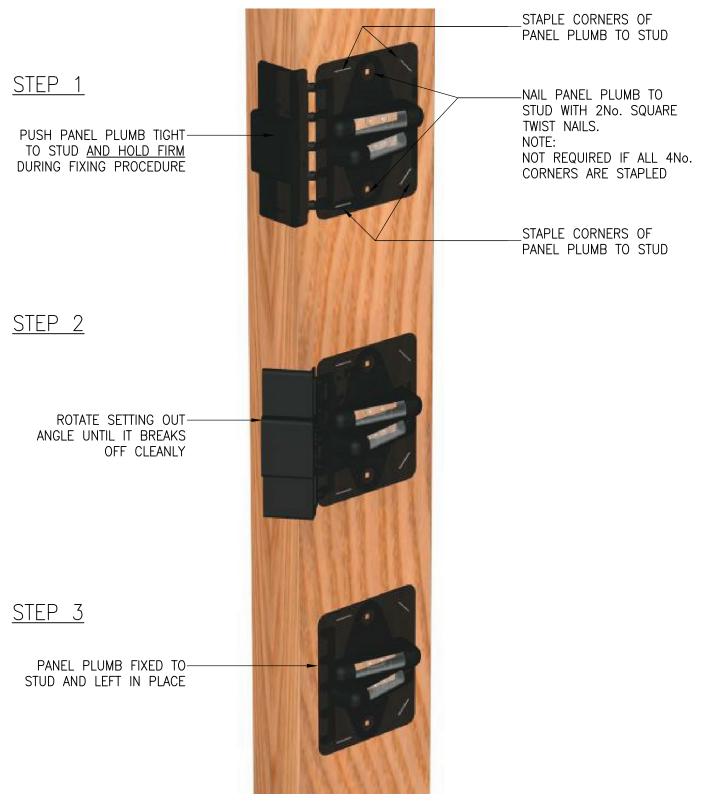
DRAWING TITLE:

SERVICES IN PARTY FLOORS

DRAWING No: REVISION: SCALE: 1:10

DRAWN BY: DATE: T.KNIGHT AUG 09

ALL TIMBER FRAME WALLS MUST BE ERECTED PLUMB TO ENSURE A GOOD QUALITY BUILD, CLEAR CAVITIES ARE MAINTAINED AND ALL STUDS ARE AXIALLY LOADED TO AVOID INDUCED BENDING FROM ECCENTRICITY. TRADA (TIMBER RESEARCH AND DEVELOPMENT AGENCY) RECOMMEND A MINIMUM OF +/- 10mm OVER ANY STOREY WITH NO MORE THAN 10mm CUMMULATIVE OVER THE BUILDING HEIGHT.



### PANEL PLUMB IS AVAILABLE FROM SILVATEC LEVELS ON THE CONTACT DETAILS BELOW.



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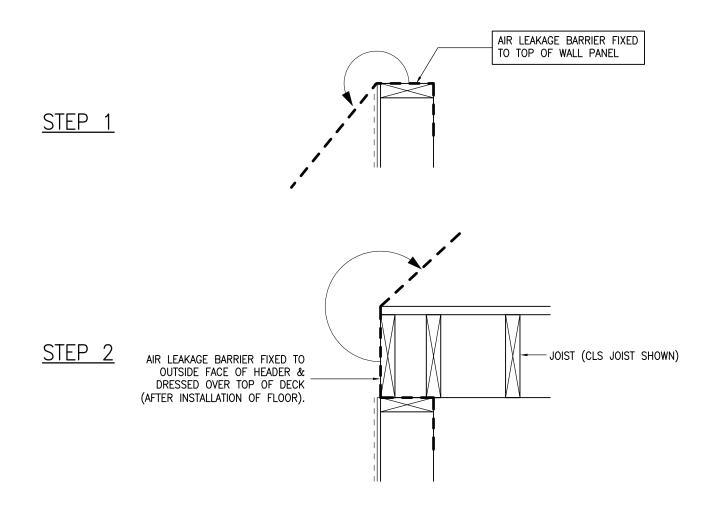
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# DRAWING TITLE: PANEL PLUMB FIXING DETAIL

DRAWING No: REVISION: SCALE:
8.1 A 1:10

DRAWN BY: DATE:
T.KNIGHT MAR 08



VAPOUR CONTROL LAYER FIXED TO INSIDE
FACE OF WALL (FULL DEPTH) & LAPPED
OVER AIR LEAKAGE BARRIER.

AIR LEAKAGE BARRIER FIXED BACK TO INSIDE
FACE OF WALL PANEL OVER.

VAPOUR CONTROL LAYER FIXED TO INSIDE
FACE OF WALL (FULL DEPTH) & LAPPED
OVER AIR LEAKAGE BARRIER.

PLASTERBOARD OVER BOTH VAPOUR CONTROL

PLASTERBOARD OVER BOTH VAPOUR CONTROL

LAYER & AIR LEAKAGE BARRIER.

STEP 3

NOTE: DPC IS NOT ACCEPTABLE AS AIR LEAKAGE BARRIER AS THE MOISTURE WILL BE TRAPPED AGAINST THE TIMBERS IN THE FLOOR ZONE. CORRECT MATERIAL MUST BE USED TO ENABLE MOISTURE TO ESCAPE BUT TRAP THE AIR MOLECULES.




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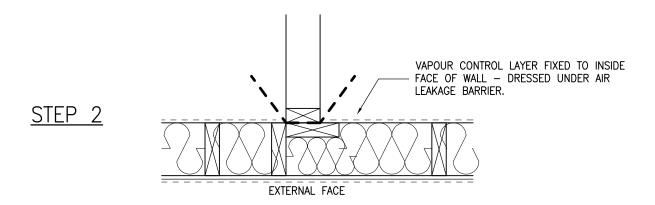
TEL: 01483 769518 FAX: 01483 770863


E-MAIL: design@silvatecdesign.com

DRAWING TITLE: AIR LEAKAGE — FLOOR JUNCTION		
DRAWING No: 9.1	REVISION: A	SCALE: 1:10
	DATE: NOV 08	

LAYER & AIR LEAKAGE BARRIER.



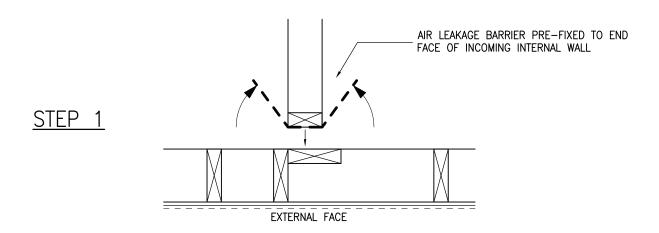


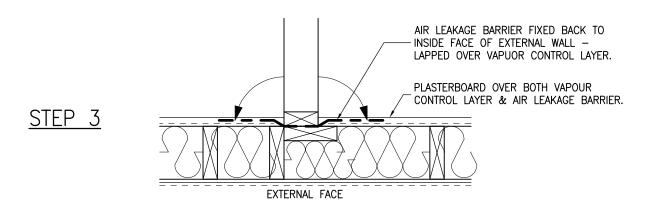




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DRAWING TITLE: AIR LEAKAGE — INTERNAL TO EXTERNAL WALL JUNCTION		
DRAWING No: 9.2	REVISION: -	SCALE: 1:10
DRAWN BY: T.ROBERTS	DATE: NOV 08	



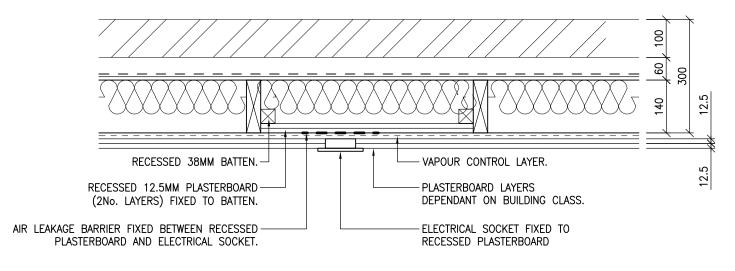

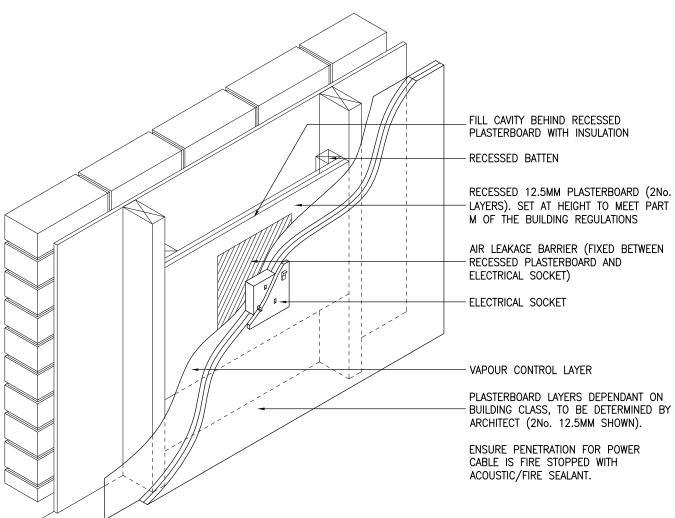


TEL: 01483 769518 FAX: 01483 770863

DRAWING TITLE: AIR LEAKAGE — ELECTRICAL SOCKETS IN EXTERNAL WALLS		
DRAWING No: 9.3	REVISION: -	SCALE: 1:10
DRAWN BY: T.ROBERTS	DATE: DEC 08	

#### LINTOLS


- -LEAVES OF LINTOLS SHOULD BE NAILED TOGETHER WITH TWO STAGGERED ROWS FOR 90mm AND 140mm LINTOLS AND THREE ROWS FOR 194mm AND 235mm LINTOLS.
- -ALL LINTOLS COMPRISING TWO 38mm THICK LEAVES ARE TO HAVE 9mm OSB SANDWITCH.
- -EACH LEAF OF THE LINTOL IS TO BE NAILED TO THE ADJACENT FULL HEIGHT STUD WITH: TWO NAILS FOR 90mm, THREE NAILS FOR 140mm, FOUR NAILS FOR 194 AND 235.
- -IN ADDITION NAIL LEAVES THROUGH TOP RAIL AT 300mm CENTRES.

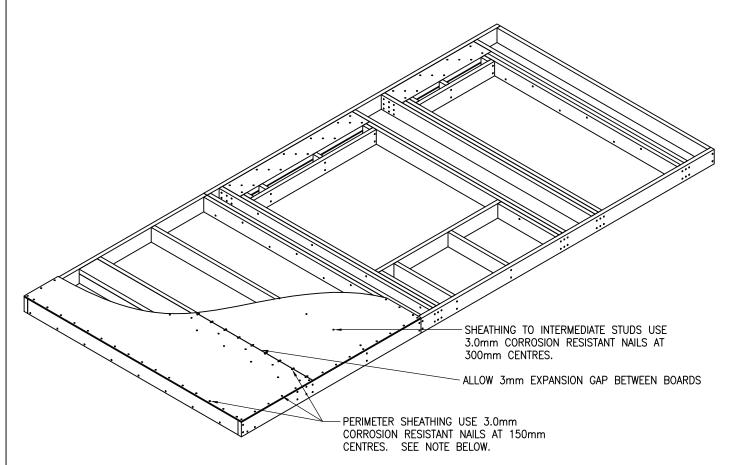

THE SHEATHING NAILING PATTERN SHOWN ABOVE IS THE STANDARD REQUIREMENT FOR THE BASIS OF THE RACKING CALCULATIONS AS PER BRITISH STANDARD BS5268-6. IT IS NOT UNCOMMON FOR MANUFACTURERS TO DEVIATE FROM THE STANDARD NAIL DIAMETER AND THIS DEVIATION MUST BE ALLOWED FOR WITHIN THE RACKING CALCULATIONS. THE NAILS CAN RANGE BETWEEN 2.55mm AND 3.75mm AS PER THE BRISTISH STANDARDS AND EACH SMALL CHANGE CAN HAVE A SIGNIFICANT EFFECT ON THE CALCULATIONS. IT IS ALSO NOT UNCOMMON FOR NAIL CENTRES TO BE DECREASED AND NAIL DIAMETERS INCREASED WITHIN THE RACKING CALCULATIONS TO PROVIDE THE NECESSARY RESISTANCE TO THE WIND. IT IS THEREFORE IMPERATIVE THAT NAIL DIAMETERS AND CENTRES ARE MARKED ON THE MANUFACTURING DRAWINGS FOR EACH PANEL.

IF A WALL PANEL IS ISSUED FOR PRODUCTION WITHOUT A SHEATHING NAILING SPECIFICATION THEN THE PRODUCTION MANAGER MUST CHECK WITH THE TIMBER FRAME DESIGNER TO CONFIRM DIAMETERS AND CENTRES.

NAILING SPECIFICATION FOR TOP AND BOTTOM RAILS TO STUDS

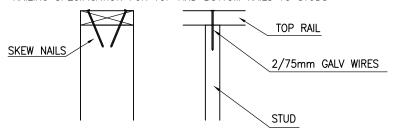



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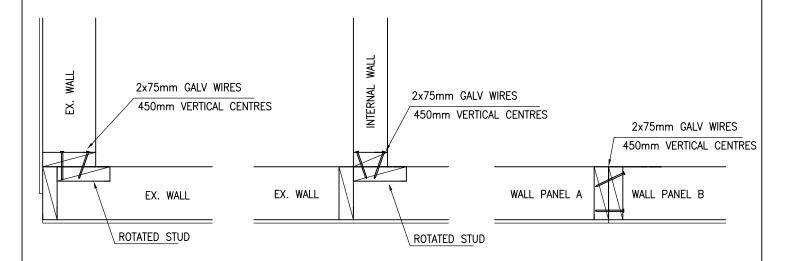
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E-MAIL: design@silvatecdesign.com


DRAWING TITLE: NAILING DETAILS — WALL PANEL ASSEMBLY

DRAWING No:	REVISION:	SCALE:
10.1	_	NTS
DRAWN BY:	DATE:	
M.SINGLIAR	DEC 08	

#### NAILING SPECIFICATION BETWEEN PARTICULAR PANELS



#### NAILING SPECIFICATION FOR PANEL-SOLEPLATE AND PANEL-TOP TIE RAIL

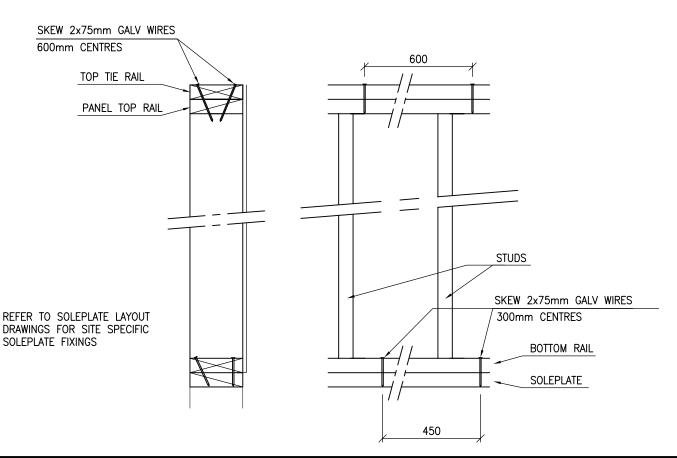




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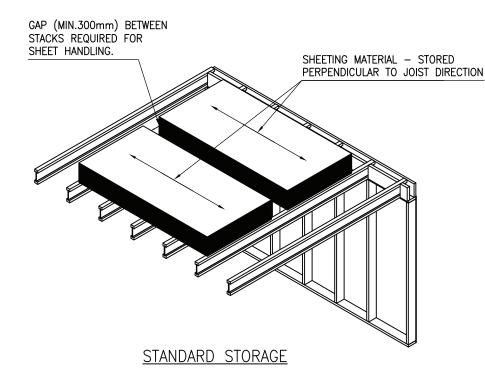
TEL: 01483 769518 FAX: 01483 770863

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DRAWING TITLE:
NAILING DETAILS —
WALL PANEL CONNECTIONS


DRAWING No:	REVISION:	SCALE:
10.2	_	1:20
DRAWN BY:	DATE:	
M.SINGLIAR	DEC 08	



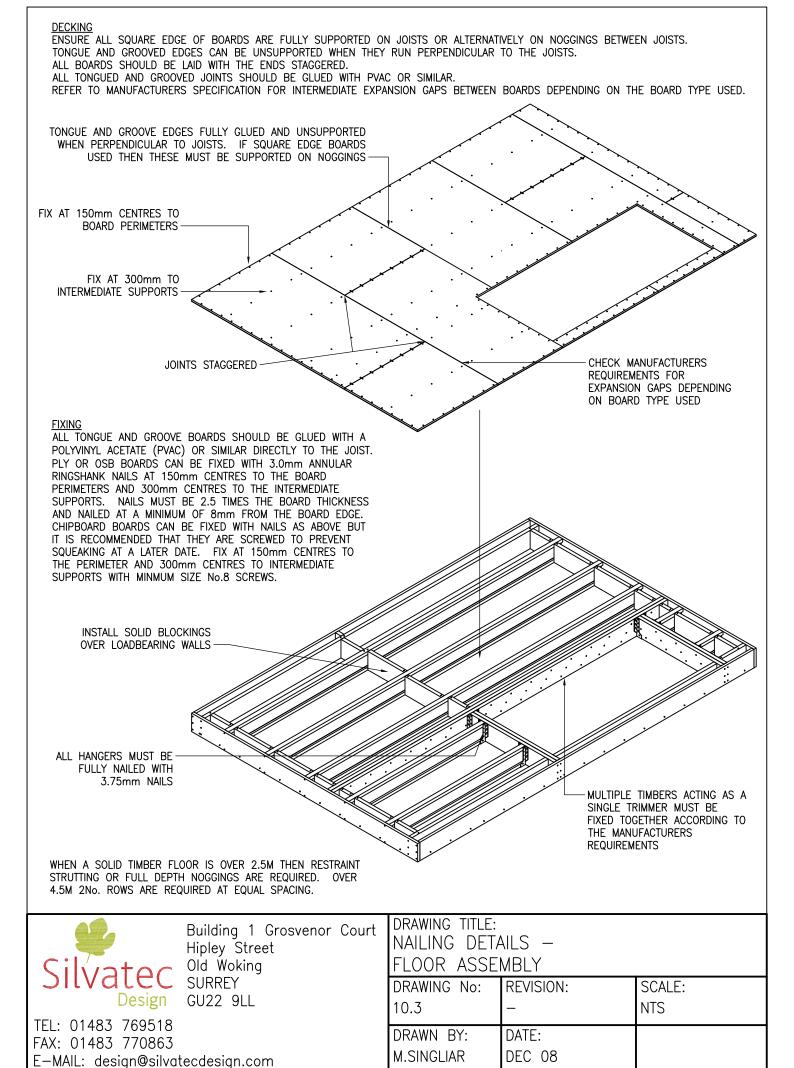

PERMISSIBLE QUANTITY OF	
SHEETS	
MAX. NO OF	
SHEETS	
9	
25	
15	
12	
15	
12	
9	

NOTE: DON'T EXCEED PERMISSIBLE QUANTITY OF SHEETS PER ONE STACK. PERMISSIBLE QUANTITY OF CHOSEN MATERIALS ARE SHOWN IN TABLE ABOVE.

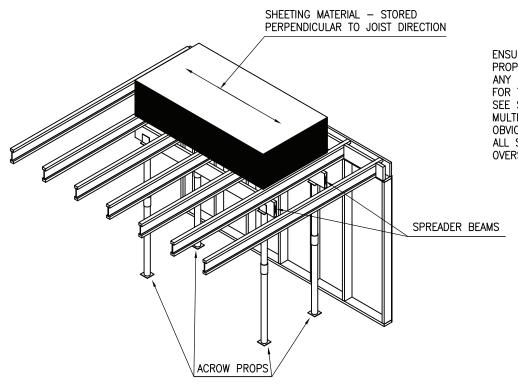

ENSURE THAT THE FLOOR IS SECURELY PROPPED PRIOR TO LOADING THE FLOOR WITH ANY LOAD GREATER THAN SPECIFIED IN TABLE. FOR TYPICAL JOIST PROPPING ARRANGEMENT SEE SKETCH — SUPPORTED STORAGE. ON MULTIPLE FLOOR BUILDINGS, PROPS WILL OBVIOUSLY HAVE TO BE CONTINUED THROUGH ALL SUBSEQUENT FLOORS DOWN TO THE OVERSITE.

SUPPORTED STORAGE



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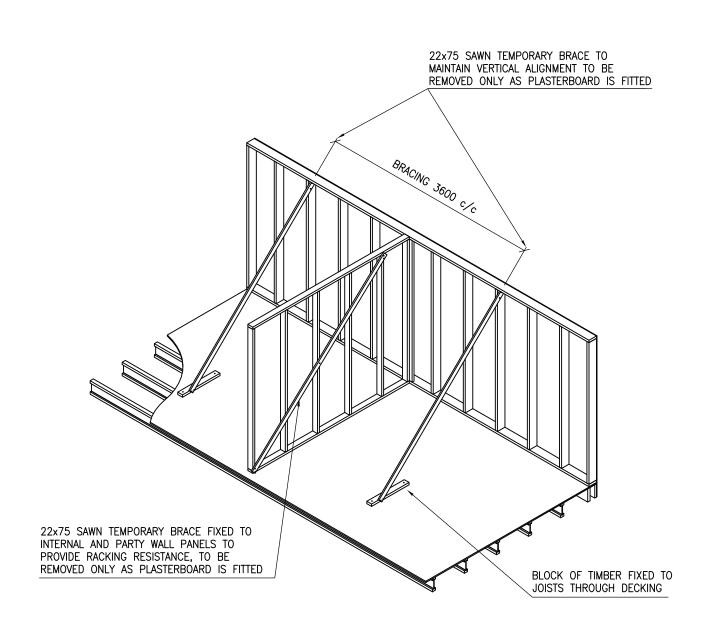
TEL: 01483 769518 FAX: 01483 770863

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DRAWING TITLE:

SHEET MATERIAL ON JOISTS

REVISION:	SCALE:
_	1:50
DATE:	
JULY 09	
	– DATE:






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E-MAIL: design@silvatecdesign.com

## DRAWING TITLE: TEMPORARY BRACING

DRAWING No: **REVISION:** SCALE: 10.5 NTS DRAWN BY: DATE: M.SINGLIAR JULY 09





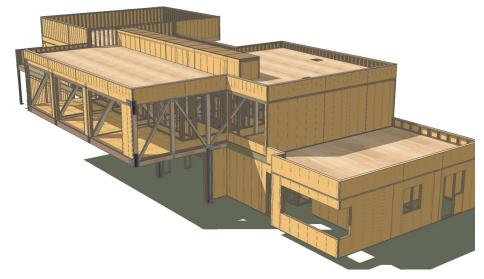

Silvatec Design Ltd Timber Frame Design and Structural Engineers

Building 1 Grosvenor Court, Hipley Street, Old Woking, Surrey GU22 9LL

Tel: 01483 769 518 Fax: 01483 770 863

Email:design@silvatecdesign.com Web: www.silvatecdesign.com



29 High Street, Billingshurst, West Sussex. RH14 9PP

Tel: 01403 782 600 Fax: 01403 783 777

Email: info@targettimber.com Web: www.targettimber.com